LATITUDE: 45° 29' 24" N LONGITUDE: 122° 49' 13" W CITY OF BEAVERTON LAND USE APPROVAL: DR2020-0079 CITY OF BEAVERTON SITE DEVELOPMENT FILE: SD2023-0002

OWNER:

M&H (SNEAD) LLC 4275 SW 139TH WAY BEAVERTON, OREGON 97006 503-284-0988

APPLICANT/OWNER AUTHORIZED REPRESENTATIVE:

ERIN UPHAM AXIS DESIGN GROUP 11104 SE STARK STREET PORTLAND, OREGON 97216 (503) 284-0988

ARCHITECT:

ERIN UPHAM AXIS DESIGN GROUP 11104 SE STARK STREET PORTLAND, OREGON 97216 (503) 284-0988

CIVIL ENGINEER:

KELLI GROVER FIRWOOD DESIGN GROUP LLC 359 E. HISTORIC COLUMBIA RIVER DRIVE TROUTDALE, OREGON 97060 (503) 668-3737

SURVEYOR:

CHRIS SHERBY S&F LAND SERVICES 4858 SCHOLLS FERRY ROAD, SUITE A PORTLAND, OREGON 97225 503-345-0328

HORIZONTAL DATUM (BASIS OF BEARINGS):

OREGON COORDINATE REFERENCE SYSTEM - PORTLAND ZONE NORTH AMERICAN DATUM OF NAD83/2011 (EPOCH 2010.0000) UNITS IN INTERNATIONAL FEET

VERTICAL DATUM:

WASHINGTON COUNTY NATIONAL GEODETIC VERTICAL DATUM OF 1929 (NGVD 29)

ORS 92.044(7) NOTE

THIS DESIGN COMPLIES WITH ORS 92.044(7) IN THAT NO UTILITY INFRASTRUCTURE IS DESIGNED TO BE WITHIN 1 FOOT OF A SURVEY MONUMENT LOCATION SHOWN ON A SUBDIVISION OR PARTITION PLAT. NO DESIGN EXCEPTION OR FINAL FIELD LOCATION CHANGE SHALL BE PERMITTED IF IT WOULD CAUSE ANY UTILITY INFRASTRUCTURE TO BE PLACED WITHIN A PROHIBITED AREA.

SHEET INDEX

COO1 COVER SHEET C100 EXIST CONDITIONS

C101 SITE PLAN

C102 GRADING AND ESC PLAN

C103 CR AND DRIVEWAY SPOT GRADING PLAN

C105 25 YEAR FLOODPLAIN STORAGE

C200 SW WHITNEY WAY

C201 SW 139TH WAY C202 TV HWY PLAN

C203 CR RAMP PROXIMITY PLAN SW TV HWY

C204 CR SPOT GRADING AT SW TV HWY

C300 ODOT DETAILS 1 C301 ODOT DETAILS 2

C302 ODOT DETAILS 3

C303 ODOT DETAILS 4

C304 WATER DETAILS

C305 FIRE HYDRANT AND DCDA DETAILS

C306 STORM DETAILS C307 STORM FILTER

C308 LIDA DETAILS

C309 SEWER DETAILS 1

C310 SEWER DETAILS 2

C311 SITE DETAILS 1

C312 SITE DETAILS 2 C313 ADA PARKING DETAILS

C314 ESC DETAILS



LEGEND <u>EXISTING</u> LOT LINE RIGHT-OF-WAY LINE MAJOR CONTOUR MINOR CONTOUR PAVEMENT SAWCUT LINE AC PAVEMENT EXIST SW SIDEWALK DRIVEWAY APPROACH TYPE 'C' CURB TRANSFORMER LUMINAIRE GAS LINE GAS VALVE WATER LINE POTABLE WATER SERVICE POTABLE WATER METER WATER VALVE FIRE HYDRANT FIRE DEPARTMENT CONNECTION (FDC) SANITARY LINE SANITARY MANHOLE CLEANOUT OIL-WATER SEPARATOR STORM LINE STORMFILTER CATCH BASIN (DOUBLE) STORMFILTER CATCH BASIN (SINGLE) CATCH BASIN MODIFIED CG-30 INLET NYLOPLAST AREA DRAIN OVERFLOW GRATE STORM MANHOLE 100-YR FLOODPLAIN —— (NGVD29) 25-YR FLOODPLAIN — · · · — · · · — · · ·

(NGVD29)

MAP SOURCE: UNITED STATES GEOLOGICAL SURVEY (USGS) 'THE NATIONAL MAP'

SCALE: 1" = 400'

NOTICE TO EXCAVATORS: ATTENTION: OREGON LAW REQUIRES YOU TO FOLLOW RULES ADOPTED BY THE OREGON UTILITY NOTIFICATION CENTER. THOSE RULES ARE SET FORTH IN OAR 952-001-0010 THROUGH OAR 952-001-0090. YOU MAY OBTAIN COPIES OF THE RULES BY

(NOTE: THE TELEPHONE NUMBER FOR THE OREGON UTILITY NOTIFICATION CENTER IS (503)-232-1987)

POTENTIAL UNDERGROUND FACILITY OWNERS

Dig | Safely.

503-464-7777

503-220-2415

503-988-3582

503-674-3300

503-617-1212


800-837-4966

CALL THE OREGON ONE-CALL CENTER 1-800-332-2344 OR 811

EMERGENCY TELEPHONE NUMBERS

NW NATURAL GAS **MULTNOMAH COUNTY** CITY OF TROUTDALE COMCAST CABLE VERIZON

CALLING THE CENTER.

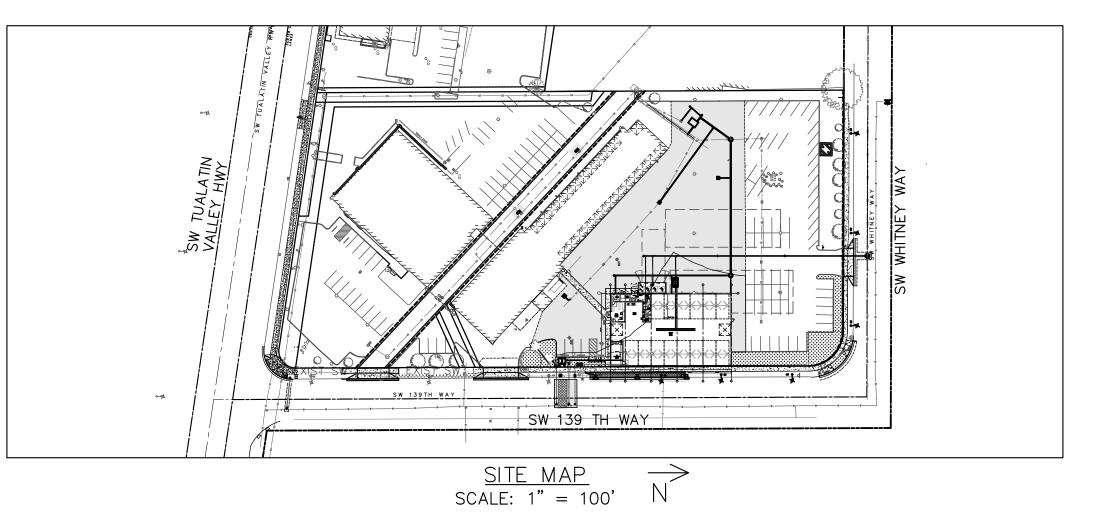

NOTES

- 1. THERE ARE PRIVATE PLUMBING SYSTEMS (POTABLE WATER, STORM DRAINAGE, AND SANITARY SEWER DRAINAGE) DEPICTED ON THESE DRAWINGS THAT ARE NOT COVERED BY THE SITE DEVELOPMENT PERMIT AND ARE NOT A PART OF THESE APPROVED PLANS. PLEASE CONTACT CITY OF BEAVERTON BUILDING DIVISION PLUMBING SECTION AT 503-526-2493 AND ASK TO SPEAK WITH THE PLUMBING LEAD FOR INFORMATION ON HOW TO OBTAIN PERMIT(S) AND INSPECTION(S).
- 2. THERE ARE PRIVATE ELECTRICAL SYSTEMS DEPICTED ON THESE DRAWINGS THAT ARE NOT COVERED BY THE SITE DEVELOPMENT PERMIT AND ARE NOT A PART OF THESE APPROVED PLANS. PLEASE CONTACT CITY OF BEAVERTON BUILDING DIVISION ELECTRICAL SECTION AT 503-526-2493 AND ASK TO SPEAK WITH THE ELECTRICAL LEAD FOR INFORMATION ON HOW TO OBTAIN PERMIT(S) AND INSPECTION(S).

EXPIRES: 06/30/25

SIGNATURE DATE: __ AXIS DESIGN GROUP AND ARE NOT TO BE



DESIGNGROUPARCHITECTURE & ENGINEERING, INC. 11104 S.E. STARK STREET PORTLAND, OR 97216 T: 503.284.0988 | F: 503.546.9276




MEIER EN-VOLVO E BUILDING VOLI NEW


REVISIONS No. Description DRAWN BY: BB CHECKED BY: KG JOB NO: E20-030 DATE: 7/26/2024 ISSUED FOR: LAND USE REVIEW SHEET TITLE COVER SHEET

SHEET NO.

C001

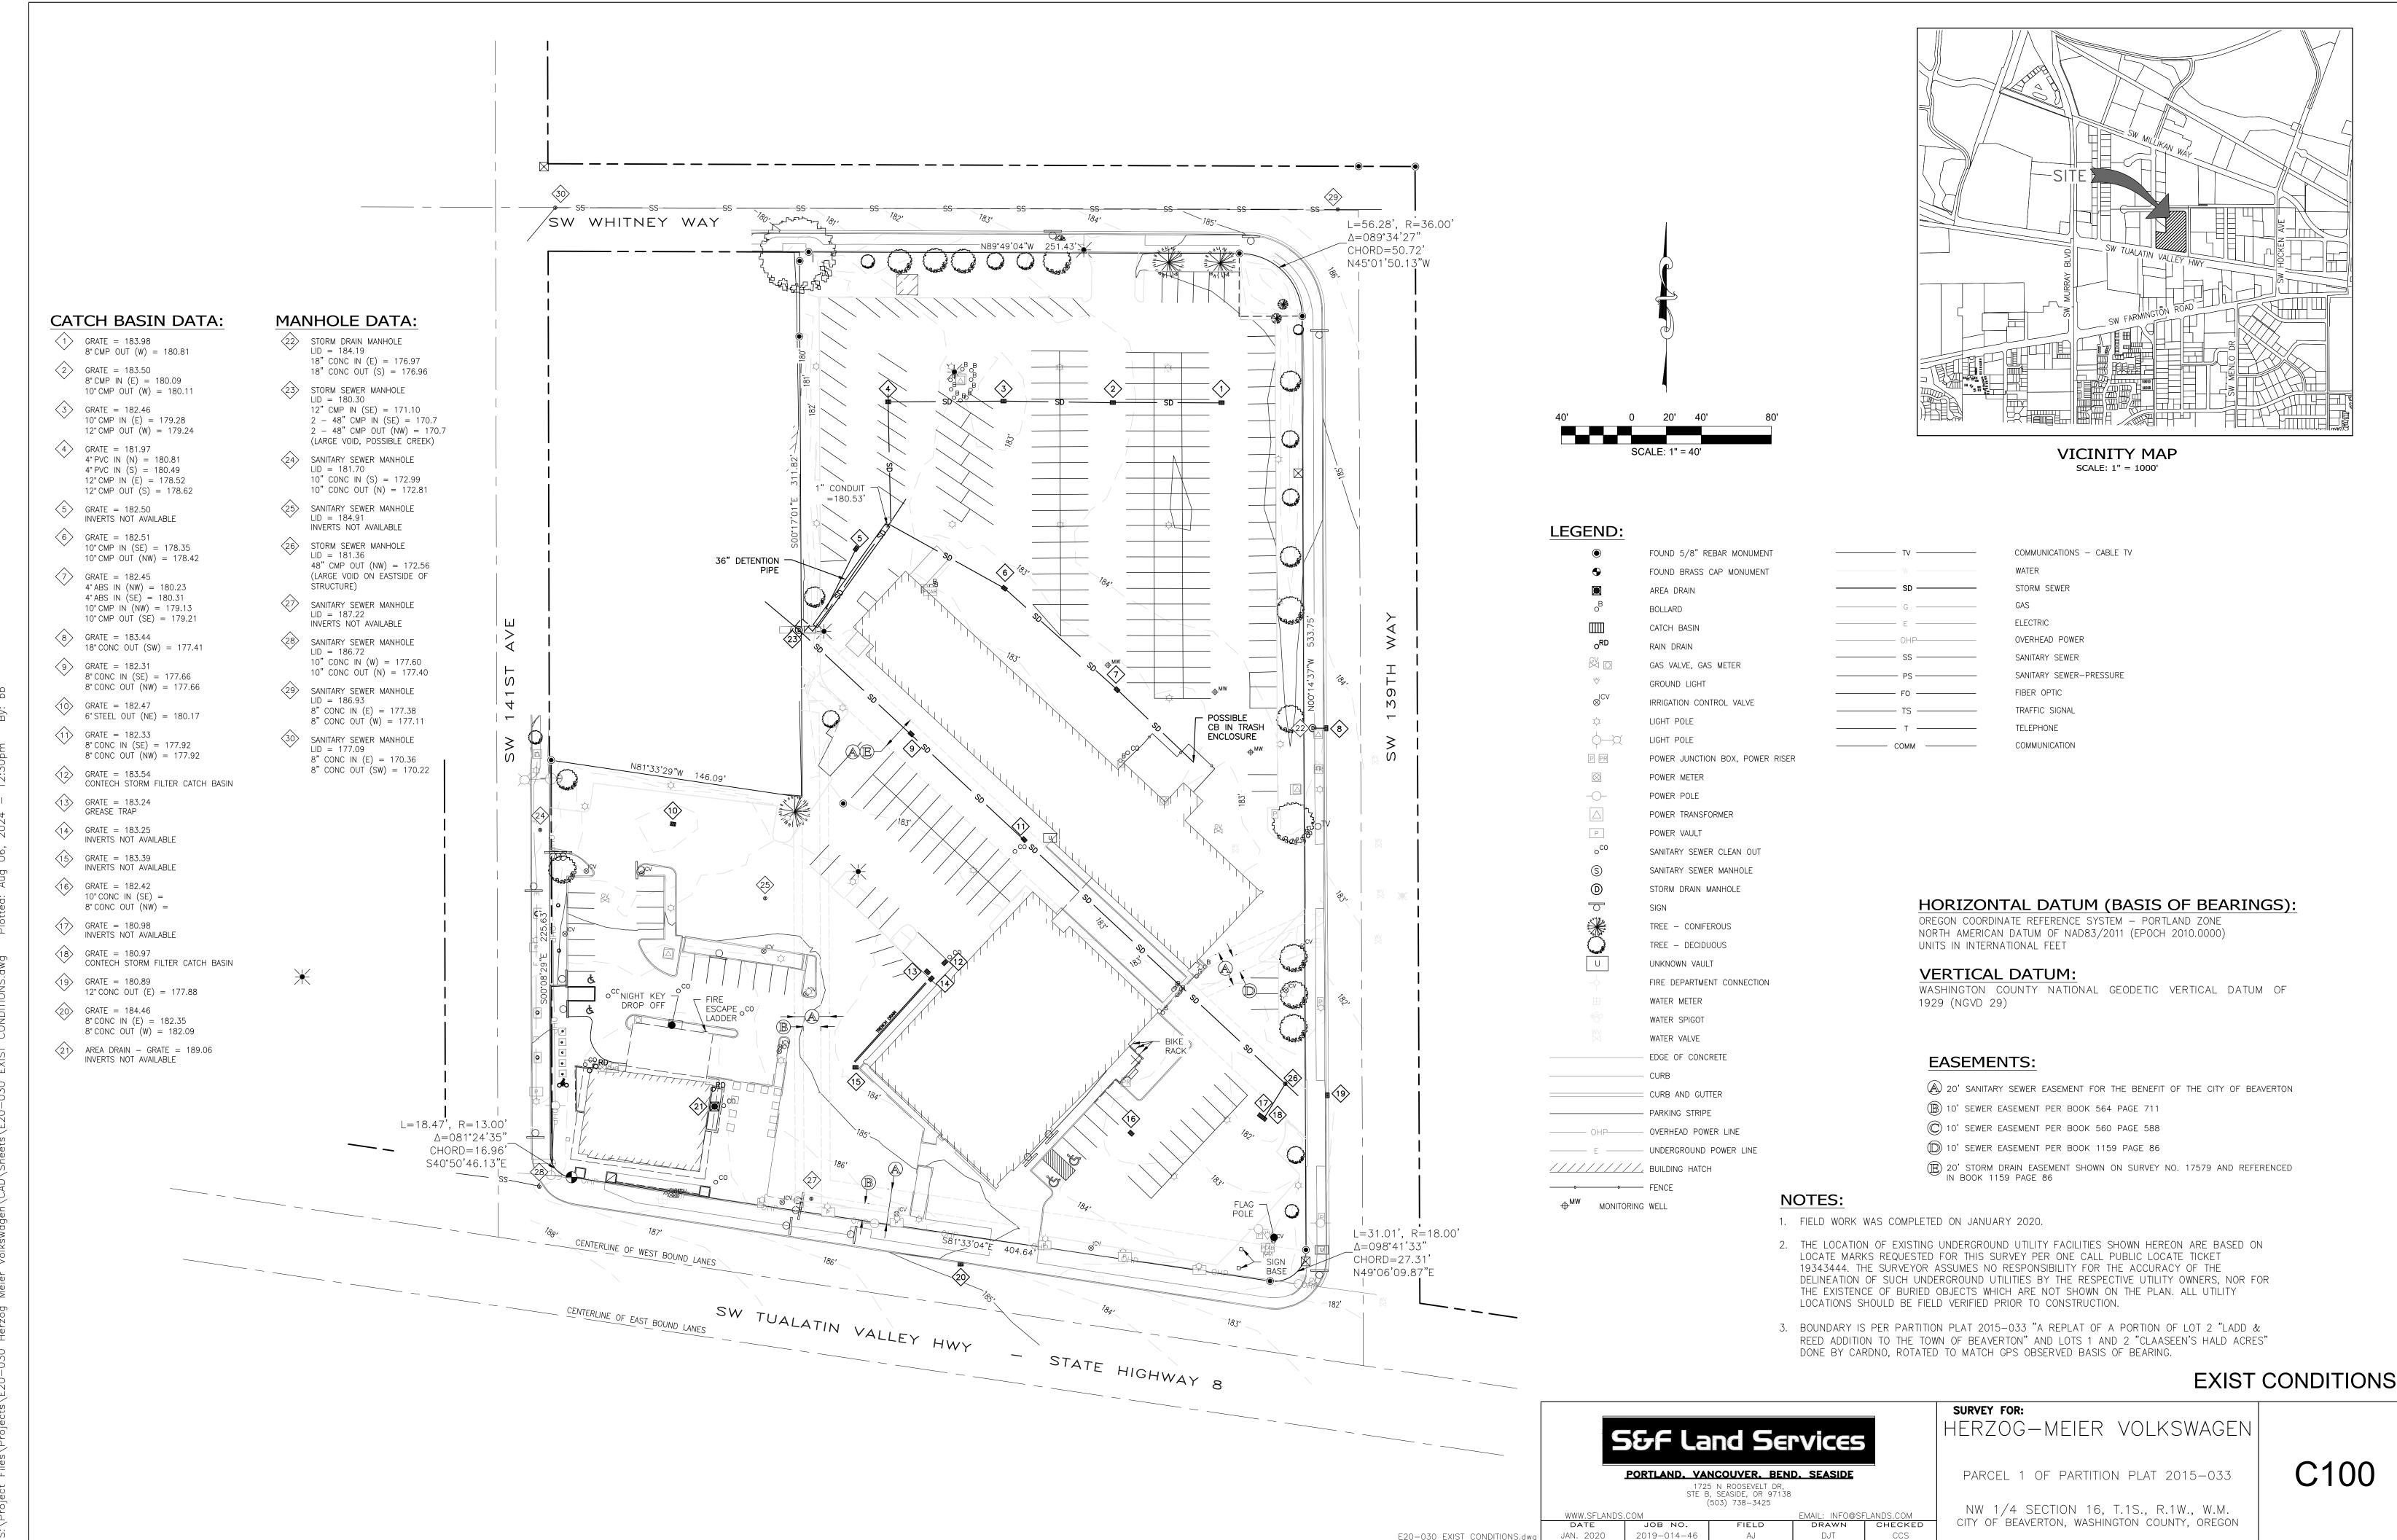

C100

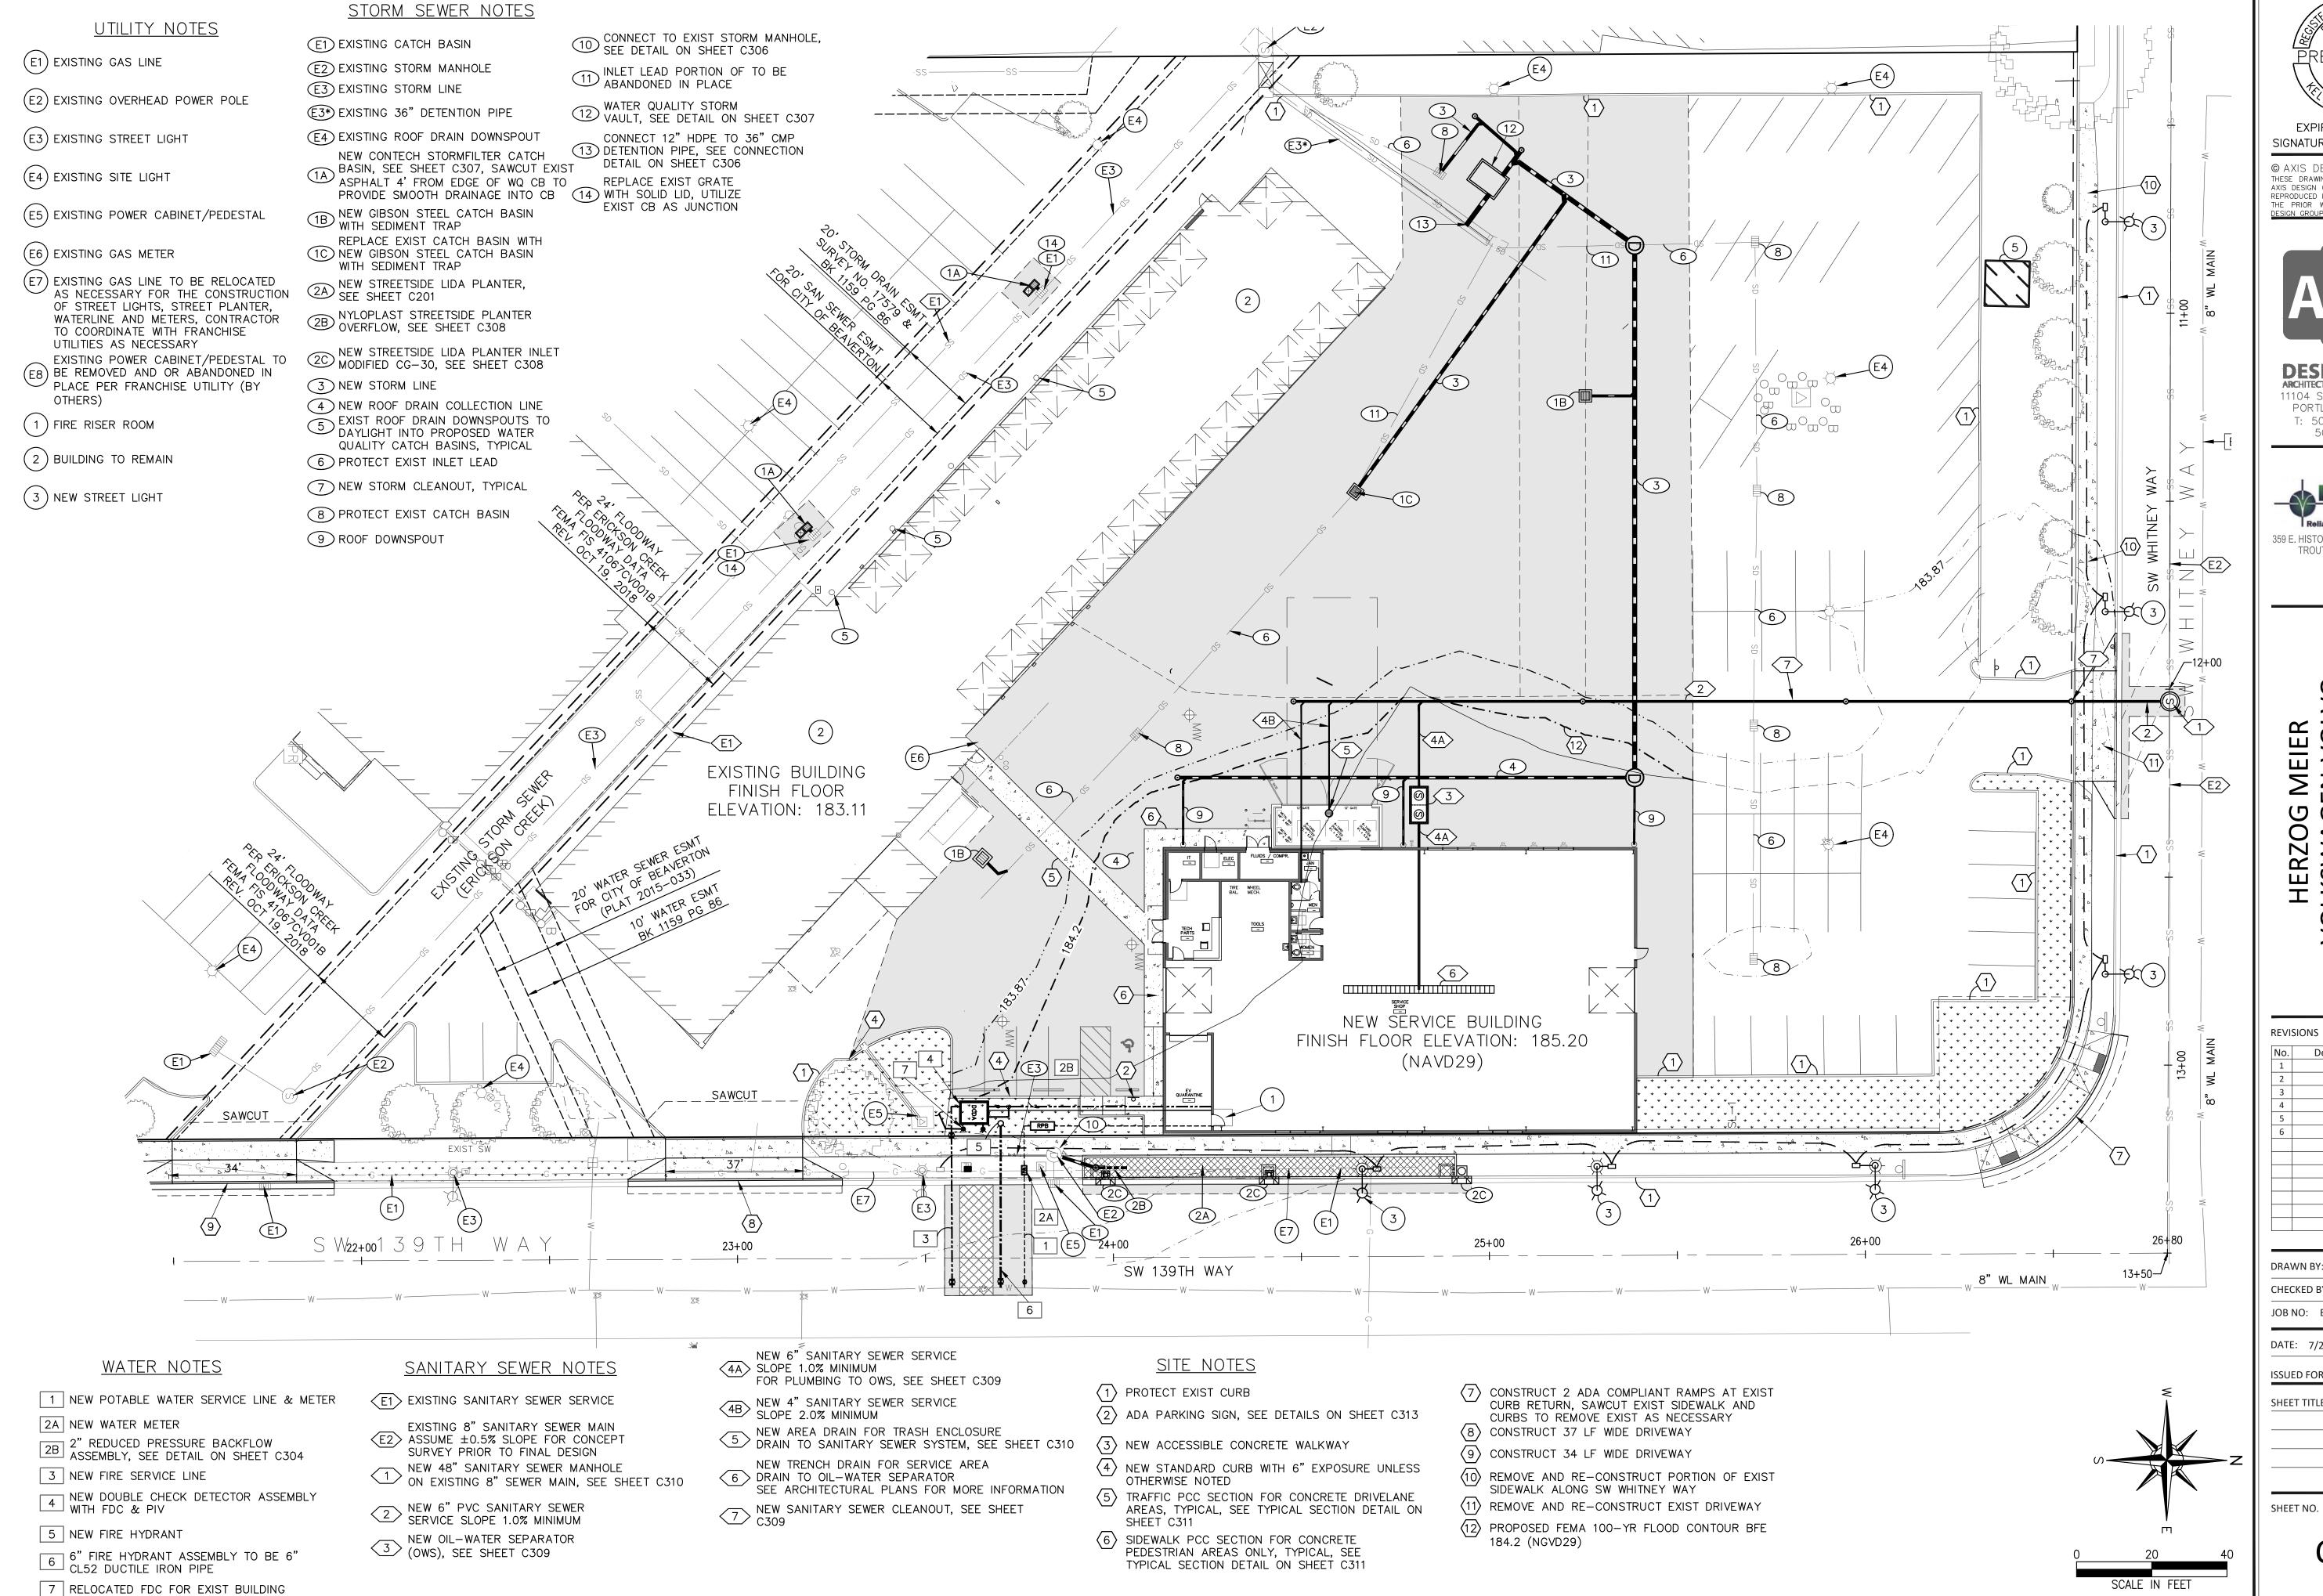

67149PE <u>P</u>reliminar<u>y</u> OREGON

EXPIRES: 06/30/25 SIGNATURE DATE: ____

© AXIS DESIGN GROUP THESE DRAWINGS ARE THE PROPERTY OF AXIS DESIGN GROUP AND ARE NOT TO BE REPRODUCED IN ANY MANNER EXCEPT WITH THE PRIOR WRITTEN APPROVAL OF AXIS




DESIGNGROUPARCHITECTURE & ENGINEERING, INC. 11104 S.E. STARK STREET PORTLAND, OR 97216 T: 503.284.0988 | F: 503.546.9276

FIRWOOD Reliable Engineering Solutions 359 E. HISTORIC COLUMBIA RIVER HWY TROUTDALE, OREGON 97060 (503) 668-3737

MEIER SEN-VOLVO SE BUILDING YAG VIC SW 13 VOL NEW


No.	Descr	iption	
1		•	
2			
3			
4			
5			
6			
DRA'	WN BY:	ВВ	
CHE	CKED BY:	KG	
JOB	NO: E20-	030	
DATI	E: 7/26/2	024	
		AND USE F	

C101

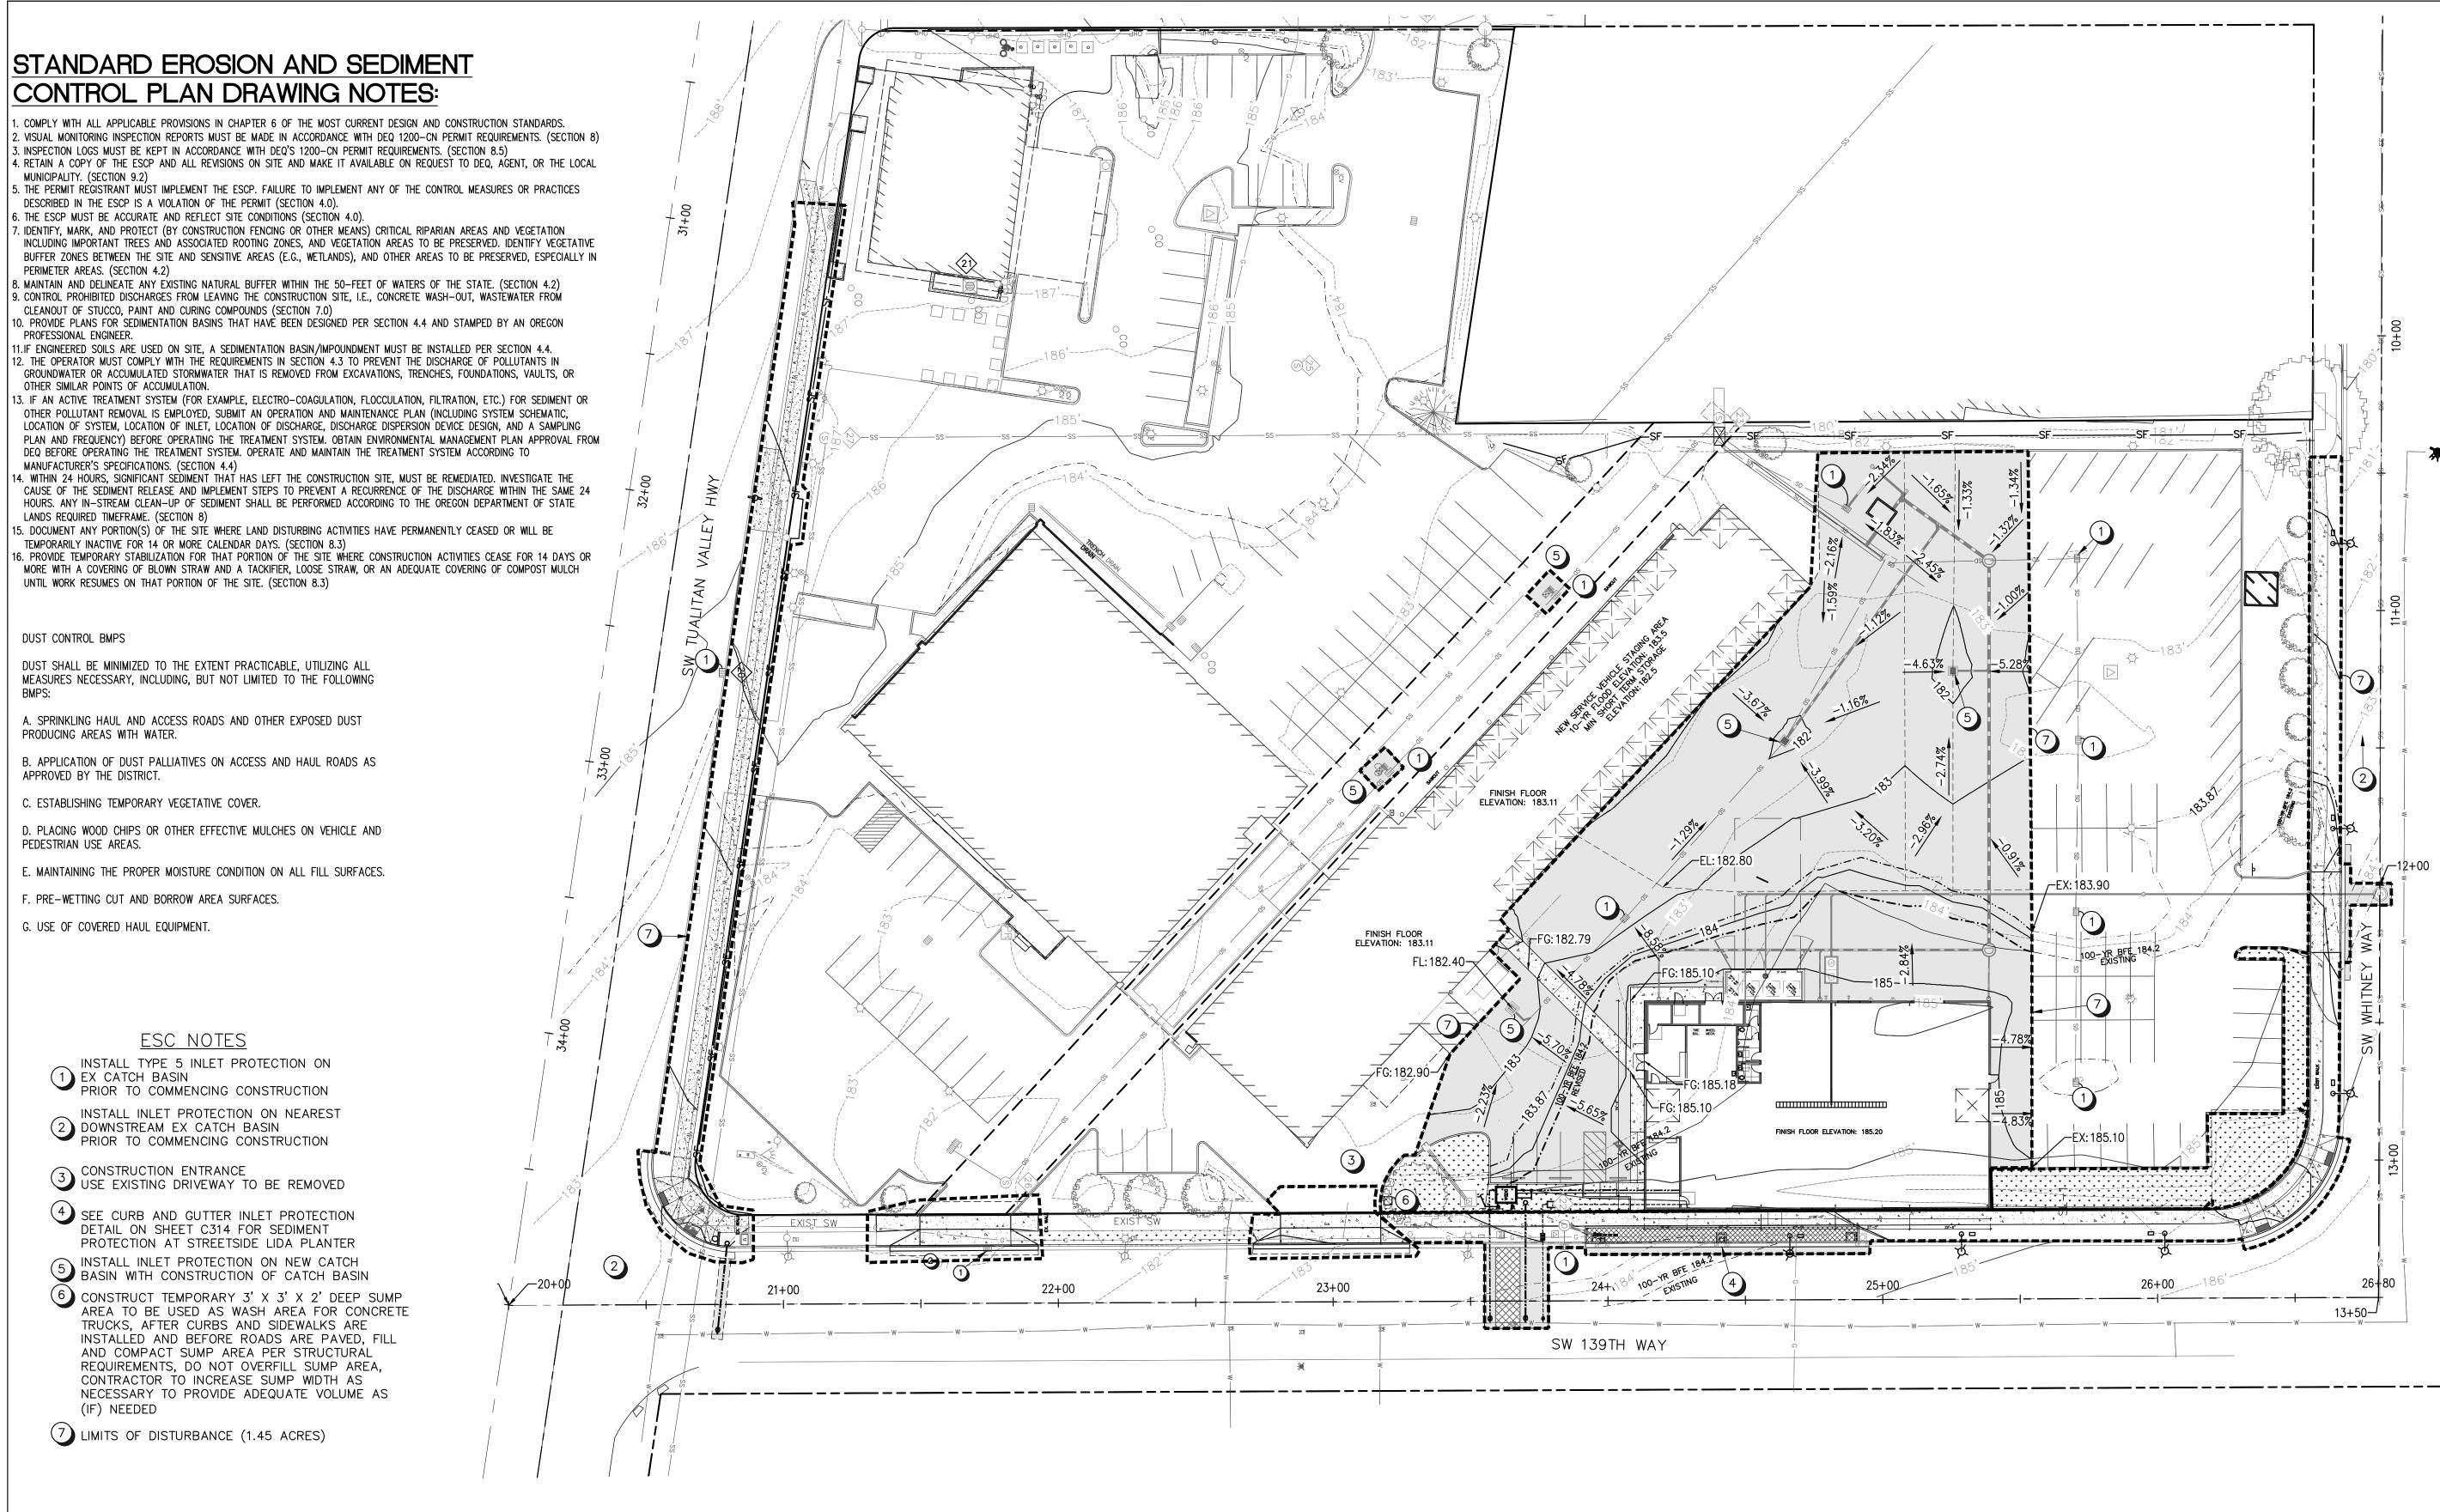

NOTES:

- 1. SEE SHEET C314 FOR EROSION AND SEDIMENT CONTROL NOTES AND DETAILS
- 2. PROPOSED AREA OF DISTURBANCE: ±1.39

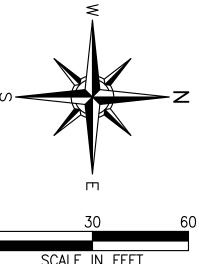



EXPIRES: 06/30/25
SIGNATURE DATE:

THESE DRAWINGS ARE THE PROPERTY OF AXIS DESIGN GROUP AND ARE NOT TO BE

REPRODUCED IN ANY MANNER EXCEPT WITH

THE PRIOR WRITTEN APPROVAL OF AXIS

© AXIS DESIGN GROUP

AXIS

DESIGNGROUP ARCHITECTURE & ENGINEERING, INC. 11104 S.E. STARK STREET PORTLAND, OR 97216 T: 503.284.0988 | F: 503.546.9276

FIRWOOD
DESIGN GROUP
Reliable Engineering Solutions
359 E. HISTORIC COLUMBIA RIVER HWY
TROUTDALE, OREGON 97060

(503) 668-3737

HERZOG MEIER OLKSWAGEN-VOLVO :W SERVICE BUILDING

No. De	escription	[
1		
2		
3		
4		\perp
5		
6		
		_
		+
		-
		+
DD AVAIN BY		
DRAWN BY:	ВВ	
CHECKED BY	/. VC	

DATE: 7/26/2024


ISSUED FOR: LAND USE REVIEW

SHEET TITLE


GRADING AND ESC PLAN

SHEET NO.


C102

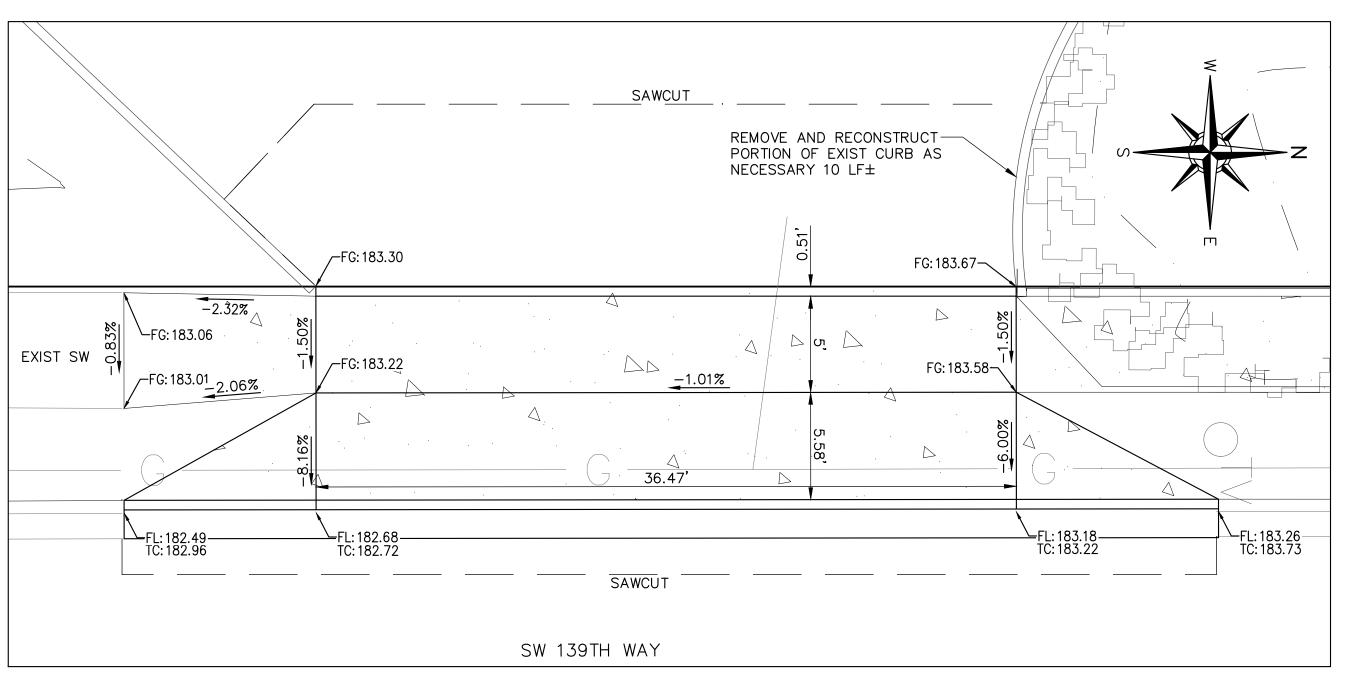


NORTH DRIVEWAY SPOT GRADING PLAN SCALE: SEE SCALE BAR 0 5 10

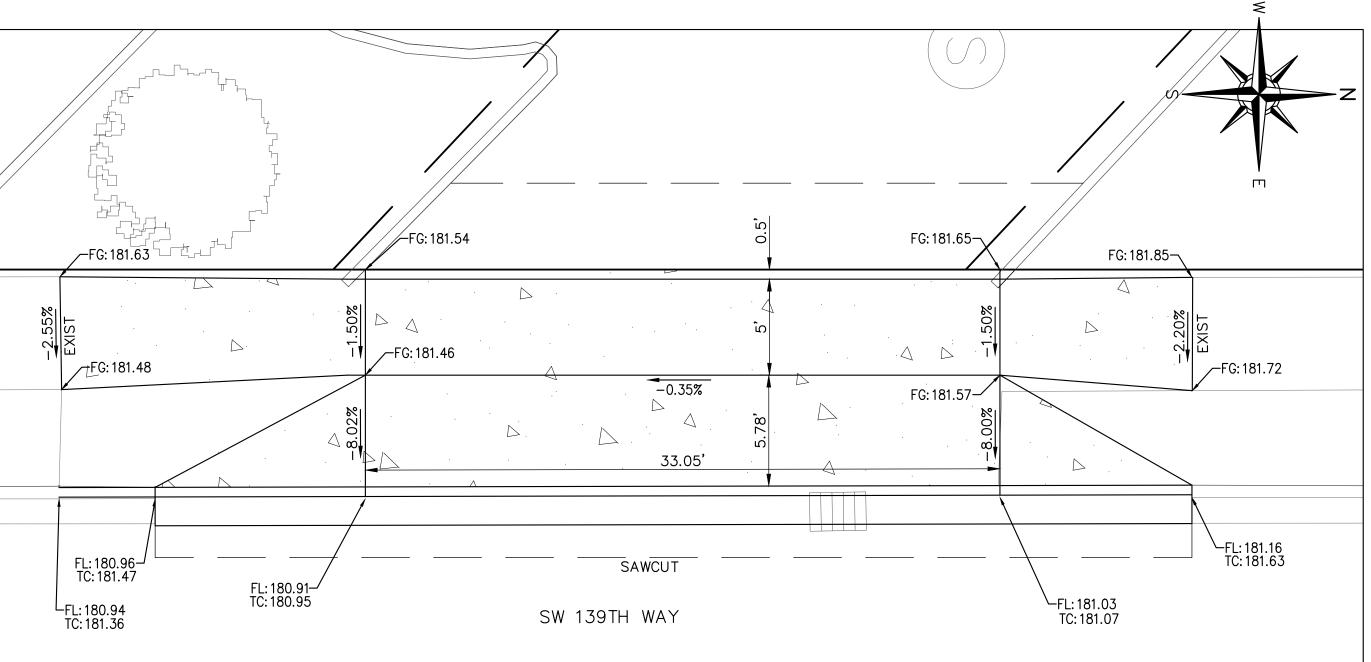

SOUTH DRIVEWAY SPOT GRADING PLAN
SCALE: SEE SCALE BAR

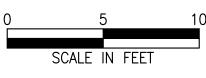

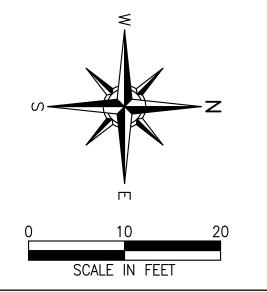



© AXIS DESIGN GROUP
THESE DRAWINGS ARE THE PROPERTY OF
AXIS DESIGN GROUP AND ARE NOT TO BE
REPRODUCED IN ANY MANNER EXCEPT WITH
THE PRIOR WRITTEN APPROVAL OF AXIS
DESIGN GROUP.



DESIGNGROUP ARCHITECTURE & ENGINEERING, INC. 11104 S.E. STARK STREET PORTLAND, OR 97216 T: 503.284.0988 | F: 503.546.9276



HERZOG MEIER VOLKSWAGEN-VOLVO JEW SERVICE BUILDING

No.	Descr	iption	
1			
2			
3			
4			
5			
6			
			_
'			
DRAWN I	BY:	ВВ	
CHECKED	BY:	KG	
JOB NO:	E20-	-030	


SHEET NO.

SHEET TITLE

C103

CR AND DRIVEWAY

SPOT GRADING PLAN

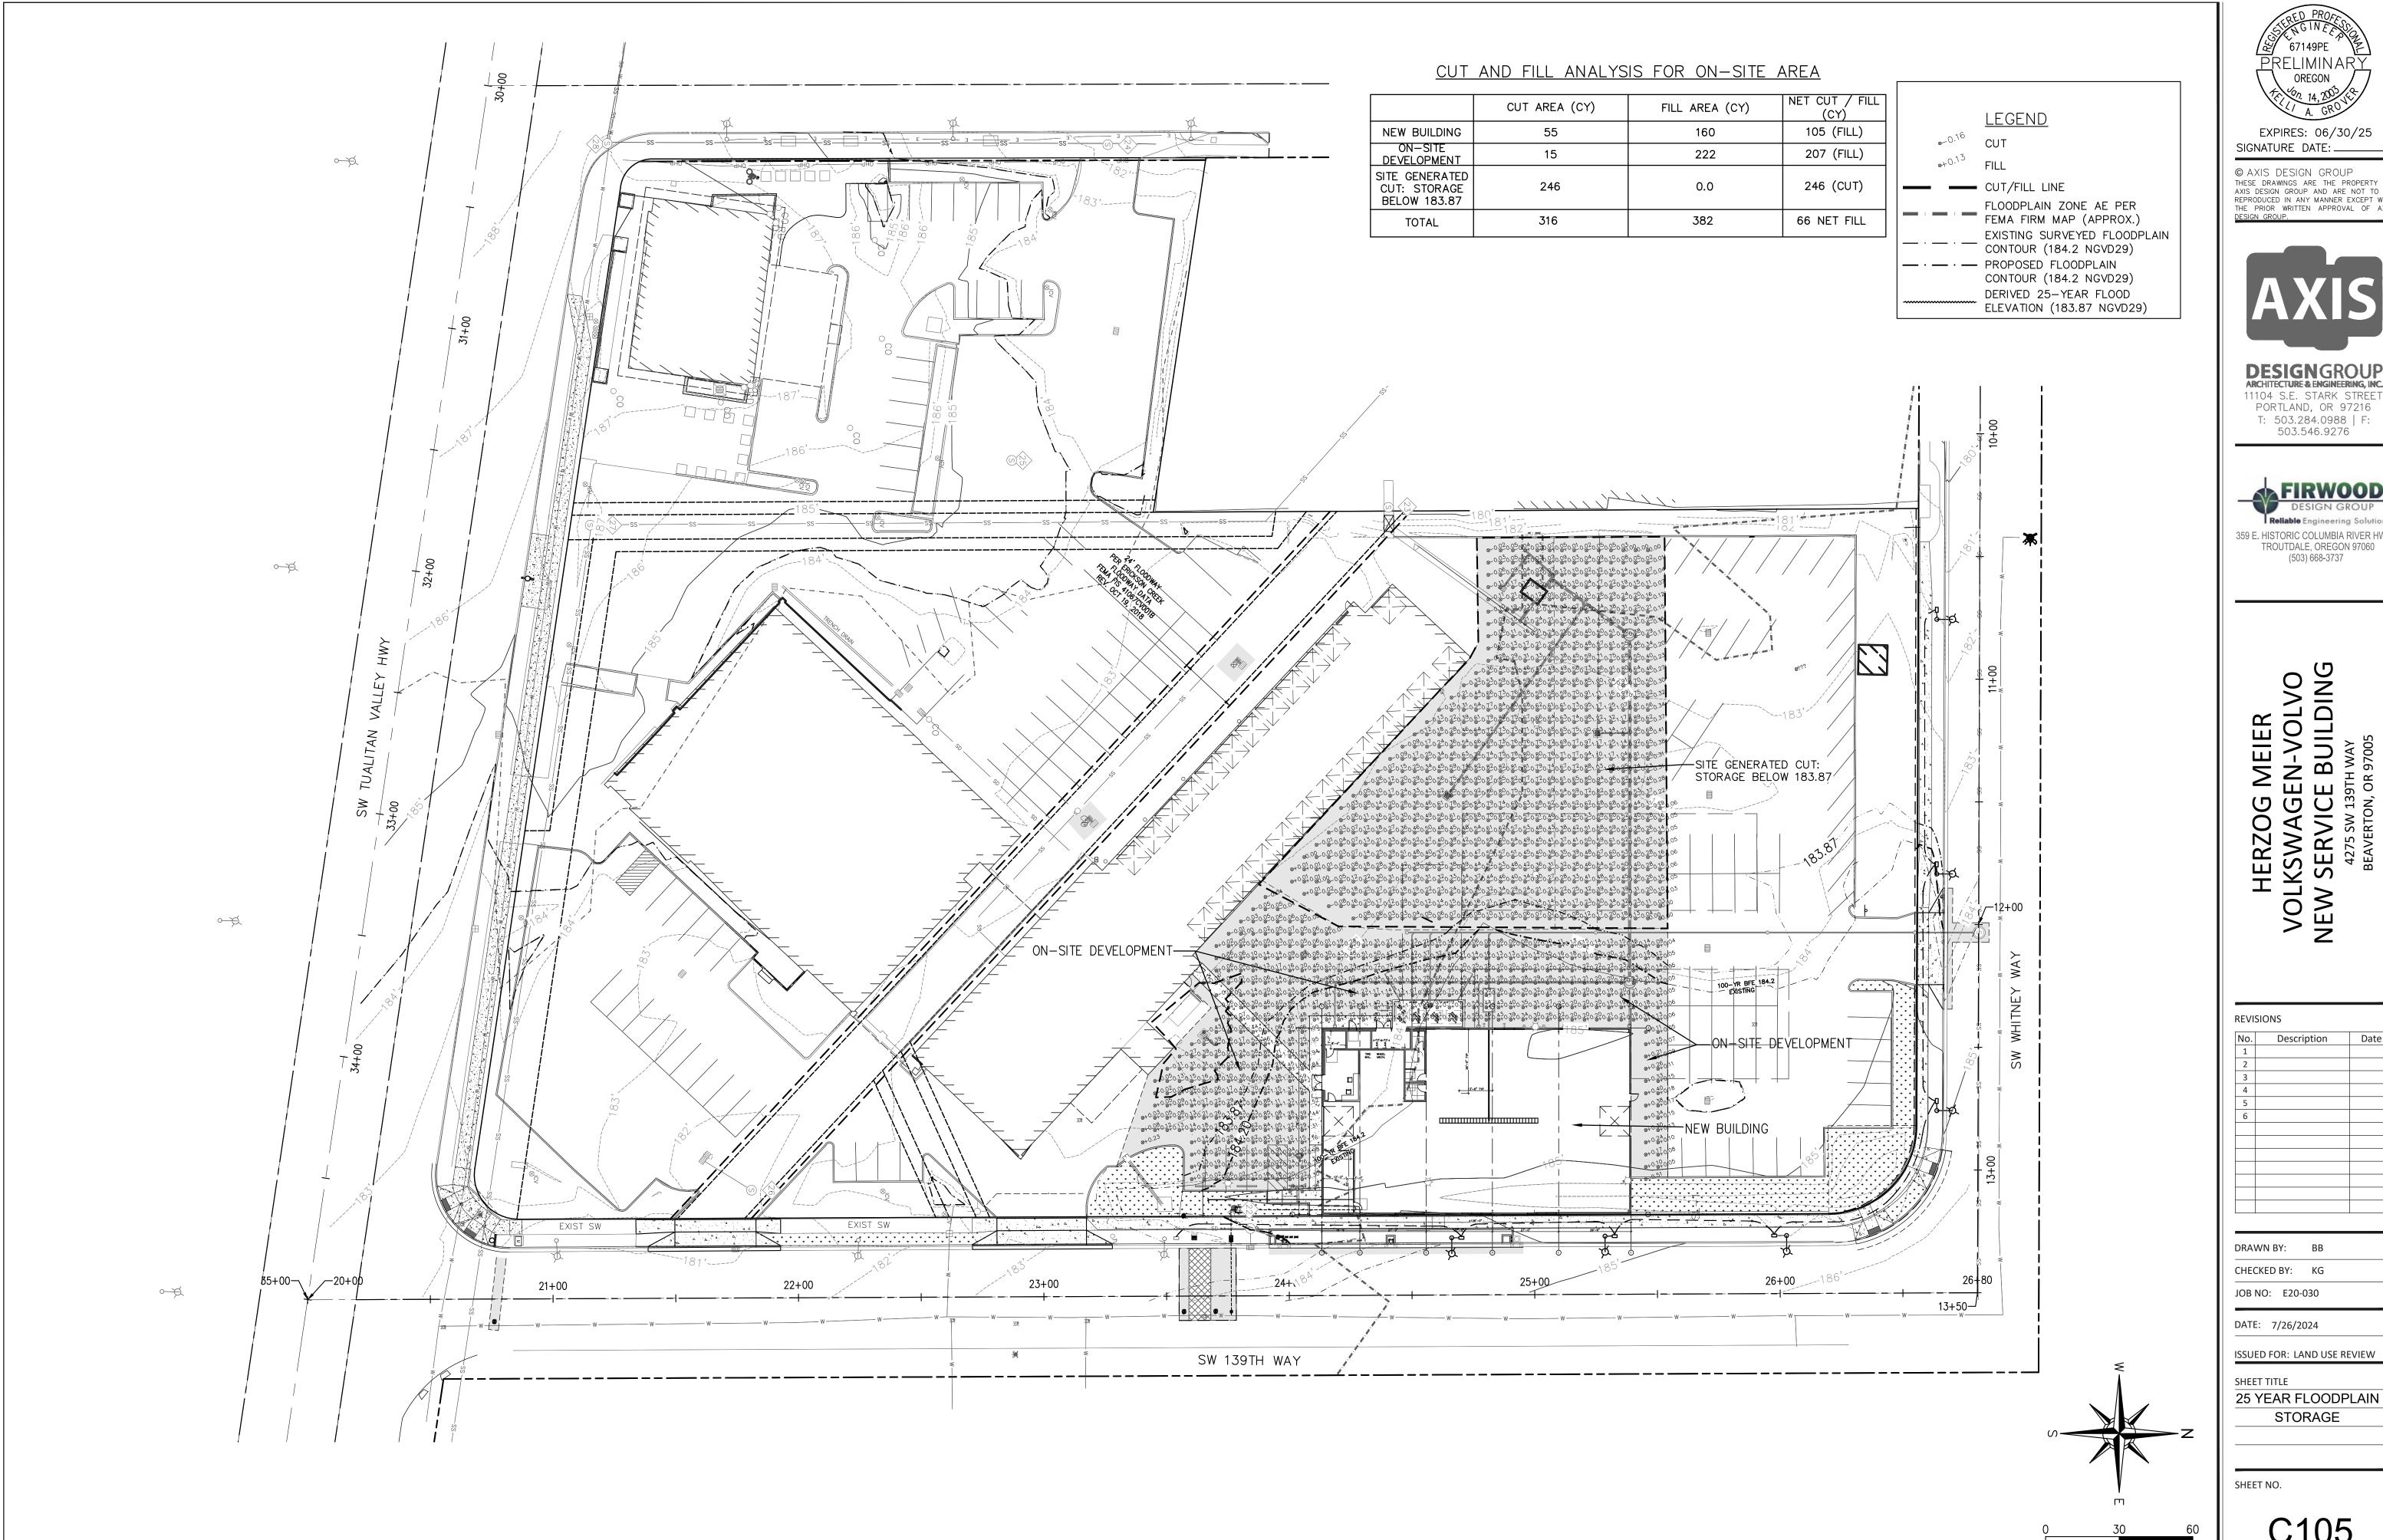



EXPIRES: 06/30/25 SIGNATURE DATE: ___

© AXIS DESIGN GROUP
THESE DRAWINGS ARE THE PROPERTY OF
AXIS DESIGN GROUP AND ARE NOT TO BE
REPRODUCED IN ANY MANNER EXCEPT WITH THE PRIOR WRITTEN APPROVAL OF AXIS DESIGN GROUP.



DESIGNGROUPARCHITECTURE & ENGINEERING, INC. 11104 S.E. STARK STREET PORTLAND, OR 97216 T: 503.284.0988 | F: 503.546.9276

FIRWOOD Reliable Engineering Solutions 359 E. HISTORIC COLUMBIA RIVER HWY TROUTDALE, OREGON 97060 (503) 668-3737

MEIER SEN-VOLVO SE BUILDING OG 'AGI VICI SW 138 ERTON,

No.	Description	Date
1	·	
2		
3		
4		
5		
6		
DRAV	/N BY: BB	
CHEC	KED BY: KG	
JOB N	IO: E20-030	

SHEET NO.

SHEET TITLE

STORAGE

EXIST TOC AND BACK OF SIDEWALK PROFILE SCALE: SEE SCALE BAR

10+00

3" LIFT BASE COURSE AC PAVEMENT —/ 3" LIFT BASE COURSE AC PAVEMENT —/ 12" OF 3/4"−0" AGGREGATE BASE— COMPACTED SUBGRADE —

SW WHITNEY WAY ACP SECTION SCALE: NTS

- 1. USE PAVEMENT SECTION SHOWN OR MATCH EXISTING, WHICHEVER GREATER. 2. AC SHALL BE LEVEL 3, 1/2" DENSE MIX ACP CONFORMING TO OSSC 00744 AND COMPACTED TO 91% MAXIMUM SPECIFIC GRAVITY AS DETERMINED BY AASHTO T-209
- 3. ASPHALT BINDER SHALL BE PG 64-22 4. AGGREGATE BASE ROCK SHALL BE COMPACTED TO 95% MIN AS DETERMINED BY MODIFIED PROCTOR (ASTM D1557)

SITE NOTES


- (1) DEMO EXIST SIDEWALK AND CURB RETURN AS NECESSARY FOR NEW SIDEWALK AND CURB RETURN CONSTRUCTION, MATCH LOCATION AND GRADE OF EXIST SIDEWALK FOR TREE PROTECTION
- 2 SEE SW WHITNEY WAY TYPICAL SECTION DETAIL THIS
- 3 CONSTRUCT DUAL ADA COMPLIANT RAMPS, SEE DETAIL ON SHEET C312
- (4) CONSTRUCT 5' SIDEWALK AT EXIST GRADE UNLESS OTHERWISE NOTED, SEE TYPICAL SECTION DETAIL THIS
- 5 1' RIGHT OF WAY RIGHT OF WAY DEDICATION ALONG SW WHITNEY WAY, TYPICAL
- 6A) CL STA 10+44.08, 20.5' RT MATCH EXIST SIDEWALK, BEGIN 20' SIDEWALK TRANSITION EAST TO 5.5' PLANTER WITH 5' SIDEWALK, MATCH LOCATION AND GRADE OF EXIST BACK OF SIDEWALK FOR TREE ROOT PROTECTION, SEE PROFILE THIS SHEET
- 6B) CL STA 12+28.13, 20.5' RT END 20' SIDEWALK TRANSITION, CONTINUE WITH 5.5' PLANTER WITH 5' SIDEWALK CONSTRUCTION, SEE PROFILE THIS SHEET
- 7 CL STA 11+73.1, 19.35' RT BEGIN 20' SIDEWALK TRANSITION TO TO 6.5' PLANTER WITH 5' SIDEWALK
- 8 CL STA 11+93.1, 20.3' RT END 20' SIDEWALK TRANSITION, CONTINUE WITH 6.5' PLANTER WITH 5' SIDEWALK CONSTRUCTION, SEE PROFILE THIS SHEET

- 9 CL STA 12+82.02, 20.5' RT BEGIN SIDEWALK RETURN, SEE CR AND DRIVEWAY SPOT GRADING PLAN ON SHEET C103
- (10) CL STA 12+91.83, 14.6' RT BEGIN CURB RETURN, SEE CR AND DRIVEWAY SPOT GRADING PLAN ON SHEET C103, SEE CURVE TABLE THIS SHEET $\langle 11 \rangle$ 139TH WAY CL STA 26+30.78,
- (12) SEE COB DETAIL 302 FOR RESTORATION OF T-CUT FOR UTILITY TIE-INS TO PUBLIC LINES

21.5' RT, END CURB RETURN

CONSTRUCTION, MATCH EXIST

(13) CL STA 12+28.13, 20.5' RT CONTINUE SIDEWALK TO CURB RETURN, SEE PROFILE THIS SHEET

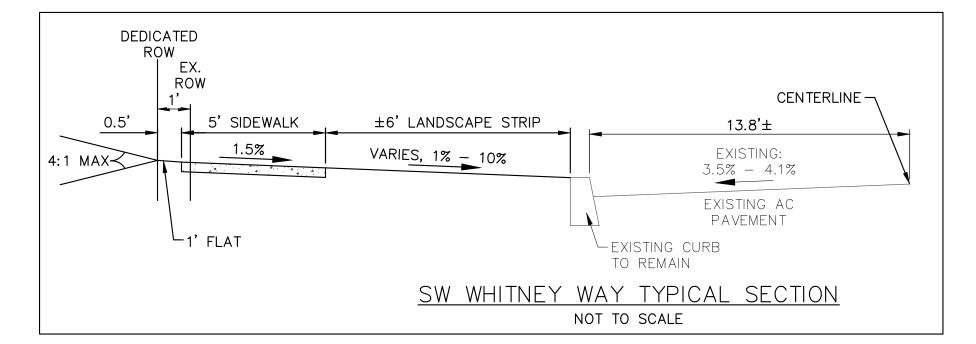

Curve Table							
Curve #	Length	Radius	Delta	Chord Direction	Chord Length		
C1	54.25	45.00	69.08	S46° 17' 13"E	51.03		
C2	51.91	30.00	99.15	N48° 58' 24"E	45.67		





DESIGNGROUP 11104 S.E. STARK STREET PORTLAND, OR 97216 T: 503.284.0988 | F: 503.546.9276



HERZ(VOLKSW/ NEW SERV

SHEET TITLE


SHEET NO.

SCALE IN FEET

C200

ISSUED FOR: LAND USE REVIEW

SW WHITNEY WAY

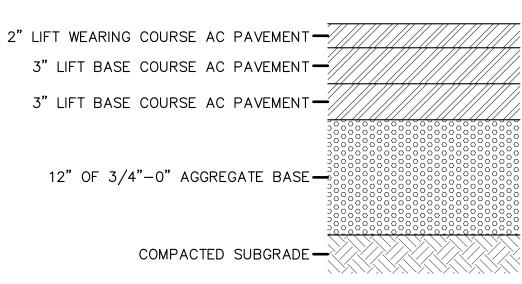

SW 39TH WAY ACP SECTION SCALE: NTS

1. USE PAVEMENT SECTION SHOWN OR MATCH EXISTING, WHICHEVER GREATER. 2. AC SHALL BE LEVEL 3, 1/2" DENSE MIX ACP CONFORMING TO OSSC 00744 AND COMPACTED TO 91% MAXIMUM SPECIFIC GRAVITY AS DETERMINED BY AASHTO T-209

3. ASPHALT BINDER SHALL BE PG 64-22

4. AGGREGATE BASE ROCK SHALL BE COMPACTED TO 95% MIN AS DETERMINED BY MODIFIED PROCTOR (ASTM D1557)

Curve Table							
Curve #	Length	Radius	Delta	Chord Direction	Chord Length		
C1	54.25	45.00	69.08	S46° 17' 13"E	51.03		
C2	51.91	30.00	99.15	N48° 58' 24"E	45.67		

SITE NOTES

 $\langle 6 \rangle$

22+00

1 DEMO PORTION OF EXIST SIDEWALK AND RECONSTRUCT SIDEWALK AT EXIST GRADE UNLESS OTHERWISE NOTED, SEE TYPICAL SECTION DETAIL THIS (17) CL STA 24+90.9, END STREET SIDE PLANTER SHEET, SEE PROFILE THIS SHEET

Δα Δ Δ


23+00

- (2) NEW STREET SIDE PLANTER (516 SF), SEE PROFILE THIS SHEET, SEE DETAILS ON SHEET C308
- $\langle 3 \rangle$ REMOVE PORTION OF EXIST SIDEWALK AND CURB AS NECESSARY TO CONSTRUCT 34' WIDE DRIVEWAY
- (4) REMOVE PORTION OF EXIST SIDEWALK AND CURB AS NECESSARY TO CONSTRUCT 37' WIDE DRIVEWAY (5) RELOCATE EXIST FDC AWAY FROM PROPOSED
- DRIVEWAY $\langle 6 \rangle$ EXIST SIDEWALK TO REMAIN
- $\langle 7 \rangle$ EXIST CURB TO REMAIN
- (8) CL STA 23+17.97, 27' LT BEGIN SIDEWALK CONSTRUCTION SEE PROFILE THIS SHEET
- $\langle 9 \rangle$ CL STA 24+47.76, 27' LT BEGIN SIDEWALK TRANSITION UP TO CONNECTION POINT, SEE PROFILE THIS SHEET
- (10) CL STA 26+20.17, 27' LT BEGIN SIDEWALK RETURN, SEE CR GRADING PLAN ON SHEET C103
- (11) CL STA 12+82.10, 20.5' RT END SIDEWALK RETURN
- (12) LIDA BEEHIVE OVERFLOW, SEE DETAILS ON SHEET
- (13) LIDA CURB CUT AND PLANTER INLET, SEE DETAILS ON SHEET C308
- (14) CURB CUT WITH MODIFIED CG-30 INLET, SEE DETAILS ON SHEET C308
- (15) SEE COB DETAIL 302 FOR RESTORATION OF T-CUT FOR UTILITY TIE-INS TO PUBLIC LINES


(16) CL STA 23+92.4, BEGIN STREET SIDE PLANTER CONSTRUCTION SEE PROFILE THIS SHEET

SW 139TH WAY


- CONSTRUCTION (18) SEE PROFILE THIS SHEET FOR BACK OF WALK ELEVATIONS AT ENTRYWAY
- 19) NEW STANDARD CURB AND GUTTER AT NEW LIDA PLANTER AREA, CL STA 23+91.9 - 24+90.9
- (20) GRIND OVERLAY AREA TO PROVIDE LARGE PATCH RESTORATION AREA PER TABLE 192.1 OF THE CITY ENGINEERING DESIGN MANUAL (FOR DISTANCES
- GREATER THAN 15 LF BETWEEN T-CUT LINES) $\langle 21
 angle$ remove portion of exist curb and gutter (cl STA 23+91.9 - 24+95.3, CONSTRUCT NEW STANDARD CURB AND GUTTER IN FRONT OF NEW LIDA PLANTER, SEE "SW 139TH WAY TYPICAL SECTION PLANTER" DETAIL THIS SHEET
- (22) CIP STORMLINE IMPROVEMENTS ARE A MINIMUM OF 7' BGS, WATERLINE INSTALLATION IN SW 139TH WAY WILL BE BETWEEN 3 AND 4' DEEP, ESTIMATED MANHOLE LOCATIONS ARE OUTSIDE OF THE ON-SITE WATER IMPROVEMENT LIMITS

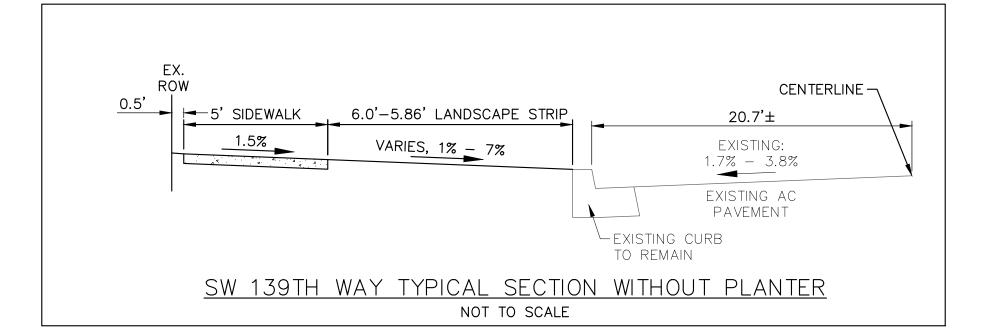

26+00

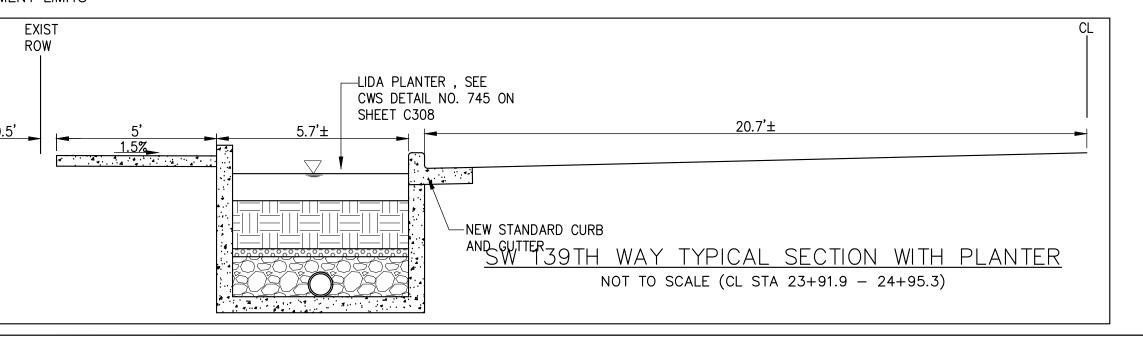

25+00

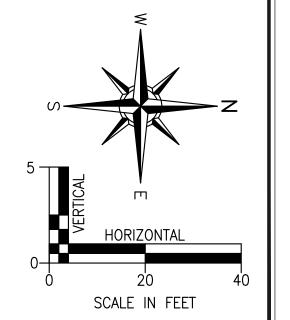

EXPIRES: 06/30/25 SIGNATURE DATE: __

© AXIS DESIGN GROUP THESE DRAWINGS ARE THE PROPERTY (AXIS DESIGN GROUP AND ARE NOT TO BE

THE PRIOR WRITTEN APPROVAL OF AXI:

DESIGNGROUP 11104 S.E. STARK STREET PORTLAND, OR 97216 T: 503.284.0988 | F: 503.546.9276

359 E. HISTORIC COLUMBIA RIVER HWY TROUTDALE, OREGON 97060 (503) 668-3737

VOL NEW


REVISIONS No. Description DRAWN BY: BB CHECKED BY: KG JOB NO: E20-030 DATE: 7/26/2024 ISSUED FOR: LAND USE REVIEW SHEET TITLE SW 139TH WAY


SHEET NO.

OF 26

<u>EXIŞT SW</u>

21+00

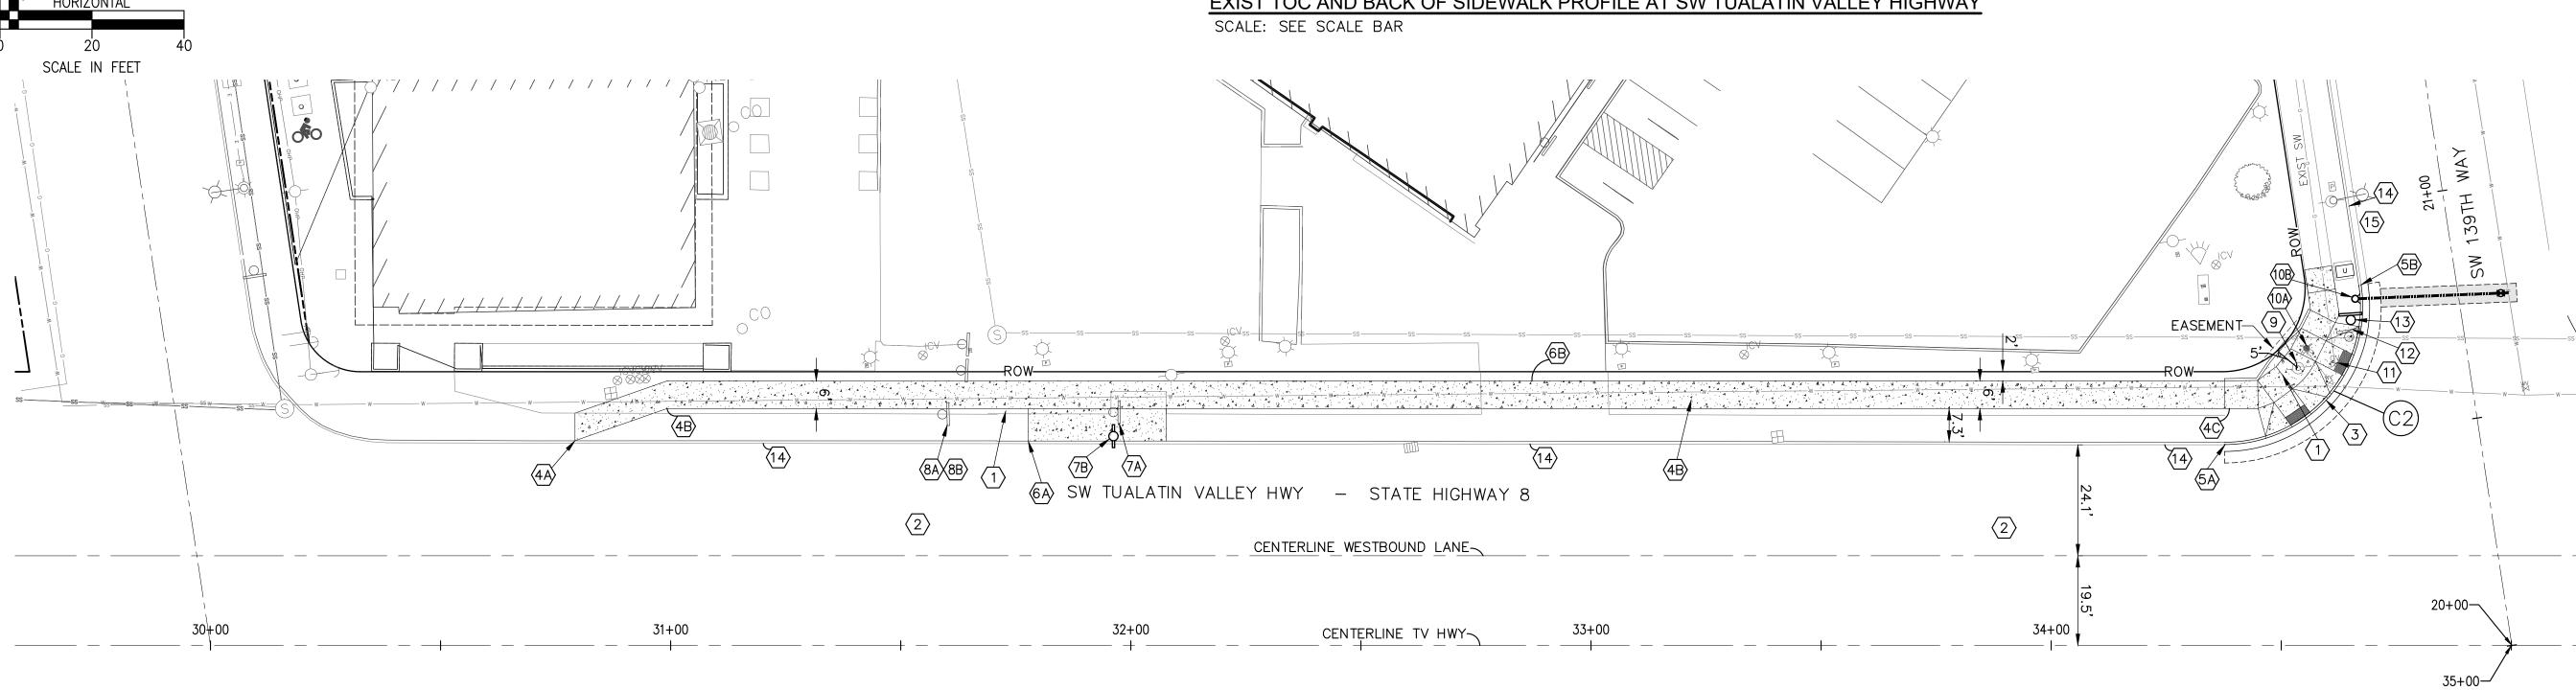

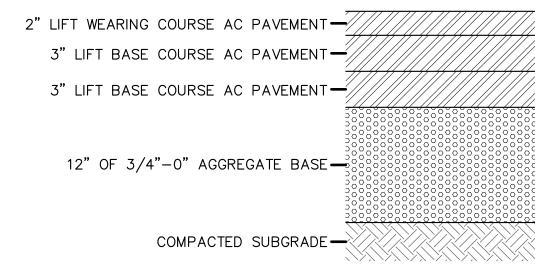

SW TUALATIN VALLEY HWY ACP SECTION SCALE: NTS

GENERAL NOTES:

- 1. USE PAVEMENT SECTION SHOWN OR MATCH EXISTING, WHICHEVER GREATER. 2. AC SHALL BE LEVEL 3, 1/2" DENSE MIX ACP CONFORMING TO OSSC 00744 AND COMPACTED TO 91% MAXIMUM SPECIFIC GRAVITY AS DETERMINED BY
- AASHTO T-209 3. ASPHALT BINDER SHALL BE PG 64-22
- 4. AGGREGATE BASE ROCK SHALL BE COMPACTED TO 95% MIN AS DETERMINED BY MODIFIED PROCTOR (ASTM D1557)
- 5. ANY DAMAGED OR CUT PAVEMENT WILL REQUIRE PAVEMENT RESTORATION, PAVEMENT RESTORATION CONSISTS OF: 2" GRIND AND INLAY USING LEVEL 3 MINIMUM MIX FOR AN AREA THAT COVERS THE ENTIRE LANE WIDTH OF EVERY LANE AFFECTED, MINIMUM OF 50' IN LENGTH
- 6. GHOST LINES WILL NOT BE ALLOWED, IF ANY PAVEMENT MARKINGS ARE REMOVED USING APPROVED METHOD AND PAVEMENT MARKINGS WILL NOT BE PLACED IN EXACT ORIGINAL LOCATION WILL TRIGGER PAVEMENT RESTORATION, SEE NOTE 5 ABOVE
- CONTRACTOR TO CONTACT TRIMET 10 DAYS BEFORE ANY WORK BEGINS AT THE BUS PAD OR FOR THE APPROACHING SIDEWALK

Curve Table							
Curve #	Length	Radius	Delta	Chord Direction	Chord Length		
C1	54.25	45.00	69.08	S46° 17' 13"E	51.03		
C2	51.91	30.00	99.15	N48° 58′ 24″E	45.67		

ODOT TRAFFIC CONTROL NOTES

- PROVIDE SAFE PASSAGE FOR PEDESTRIANS EITHER THROUGH THE CONSTRUCTION, OR REROUTED (ABOUND THE CONSTRUCTION LITERATIVE CONSTRUCTION OF STRUCTION OF S 1. WHEN CONSTRUCTION ACTIVITIES BLOCK OR INTERFERE WITH NORMAL PEDESTRIAN ROUTING, AROUND THE CONSTRUCTION, UTILIZING ODOT STANDARD DRAWING TM844 AND THE REQUIREMENTS OF THE 2018 OREGON STANDARD SPECIFICATIONS FOR CONSTRUCTION (BLACK BOOK), PAGE 150 & 151, SUBSECTION 00220.02(B).
- 2. WHEN CONSTRUCTION ACTIVITIES BLOCK OR INTERFERE WITH NORMAL OPEN STATE HIGHWAY SHOULDER CONDITIONS, AND THESE IMPACTS LAST LONGER THAN 72 HOURS, FOLLOW THE TEMPORARY SIGNING AND DELINEATION REQUIREMENTS OF ODOT STANDARD DRAWINGS TM800, TM841, TM842, TM850 AND TM851.
- 3. ANY ABRUPT EDGE GREATER THAN 2 INCHES IN DEPTH, CLOSER THAN 4 FEET FROM AN ACTIVE TRAFFIC LANE, AND HAVING A DURATION LONGER THAN 72 HOURS, SHALL BE REQUIRED TO FOLLOW THE "TYPICAL ABRUPT EDGES SIGNING DETAIL" ON ODOT STANDARD DRAWING TM800.
- 4. WHEN CONSTRUCTION ACTIVITIES BLOCK OR INTERFERE WITH SHOULDERS OR BIKE LANES, INSTALL A 48 INCH "BICYCLES ON ROADWAY" (CW11-1) SIGN IN ADVANCE OF EACH SHOULDER OR BIKE LANE CLOSURE AT SIGN SPACING "A" FROM THE "TCD SPACING TABLE" SHOWN ON ODOT STANDARD DRAWING TM800.
- 5. IF THERE ARE LANE CLOSURES ON TV HIGHWAY FOR THE CONSTRUCTION WORK ZONE AND CONTRACTOR CAN NOT ACCOMMODATE A TRAVEL LANE FOR ANNUAL LOADS OF 16' AND/OR OVERSIZE LOADS UP TO 28' (WITH ADVANCED 20 MINUTES), PLEASE FOLLOW THE MOBILITY PROCEDURES MANUAL

HTTPS: //WWW.OREGON.GOV/ODOT/MCT/DOCUMENTS/MOBILITYPROCEDUREMANUAL.PDF


SITE NOTES

- (1) DEMO EXIST CURB TIGHT SIDEWALK AND CURB RETURN AS NECESSARY FOR NEW SIDEWALK AND CURB RETURN CONSTRUCTION, SEE SIDEWALK DETAILS ON SHEET C301
- 2 SEE SW TUALATIN VALLEY HIGHWAY TYPICAL SECTION DETAIL THIS SHEET
- (3) REMOVE EXIST CURB AND CURB RAMP, RE-CONSTRUCT NEW CURB AND GUTTER AND DUAL ADA COMPLIANT RAMPS OPTION "CC-3", SEE SPOT GRADING PLAN ON SHEET C203, SEE ODOT DETAILS ON SHEETS C300 AND
- (4A) CL STA 30+79.2 MATCH EXIST EDGE OF SIDEWALK, REMOVE FULL SIDEWALK PANELS ONLY, BEGIN 20' TRANSITION TO 7' LANDSCAPE BEHIND CURB WITH 6' SIDEWALK, SEE TYPICAL SECTION DETAIL THIS SHEET
- CONSTRUCTION, SEE DETAIL ON SHEET C301 (4C) CL STA 34+38.7, 51.5' LT END SIDEWALK CONSTRUCTION, BEGIN RETURN RAMPS AND
- RETURN WALKWAY CONSTRUCTION (5A) CL STA 34+37.7 BEGIN CURB RETURN CONSTRUCTION, SEE CURVE TABLE THIS SHEET (5B) CL STA 20+82.4 END CURB RETURN

CONSTRUCTION

- (6A) REMOVE AND RECONSTRUCT BUS PAD IN 7' PLANTER BEGIN CL STA 31+77.7 TO 32+07.7 (30 LF), SEE PROFILE THIS SHEET, SEE GENERAL NOTE 7 THIS SHEET
- (6B) SAWCUT AND REMOVE PORTION OF EXIST SITE CONCRETE AS NECESSARY FOR SIDEWALK CONSTRUCTION, NEW SIDEWALK TO MATCH EXIST CONCRETE EDGE, SEE PROFILE THIS SHEET
- 7A REMOVE AND PROTECT FOR RE-USE EXIST BUS STOP SIGN POLE WITH SINGLE SEAT ATTACHMENT, REMOVAL TO BE COORDINATED WITH TRI-MET, SEE GENERAL NOTE 7 THIS SHEET (7B) RE-INSTALL EXIST BUS STOP SIGN POLE WITH
- SINGLE SEAT ATTACHMENT, RE-INSTALLATION TO BE COORDINATED WITH TRI-MET, SEE GENERAL NOTE 7 THIS SHEET
- 8A REMOVE EXIST WOODEN SIGN POST (DISCARD WOODEN POST) AND PROTECT FOR RE-USE INTERSECTION ADVANCE WARNING SIGN
- (8B) INSTALL NEW 2" X 2" 12 ga. PSST 1 POST SIGN SUPPORT AND RE-MOUNT SAVED INTERSECTION ADVANCE WARNING SIGN IN PLANTER STRIP, SEE DETAILS ON SHEETS C302 AND C303
- (9) PROTECT EXIST POWER POLE, PROVIDE 5' CLEAR SPACE AROUND EXIST POWER POLE (10A) RELOCATE EXIST FIRE HYDRANT ASSEMBLY TO NEW LOCATION PER CITY DIRECTION, HYDRANT MUST NOT BE

- 10B RELOCATED FIRE HYDRANT ASSEMBLY, CONTRACTOR TO GET CITY OF BEAVERTON APPROVAL BEFORE INSTALLATION, SEE
- DETAILS ON SHEET C304 $\langle 11
 angle$ EXIST GAS VALVE TO BE RELOCATED BY
- OTHERS, CONTRACTOR TO COORDINATE (12) REMOVE EXIST WOODEN SIGN POST (DISCARD WOODEN POST) AND STOP AND ROAD SIGNS, RETAIN STOP AND ROAD SIGNS FOR RE-MOUNTING ON NEW POST
- (13) INSTALL NEW 2 1/4" & 2 1/2" 12 ga. PSST 1 POST SIGN SUPPORT AND RE-MOUNT EXIST STOP AND ROAD SIGNS, AND MOUNT NEW "TV Hwy" SIGN ON BOTH TV HWY SIDE AND SW 139TH WAY SIDE, SEE SIGN DESIGN DETAILS AND SIGN TREE DETAIL ON SHEET C301, SEE SIGN ATTACHMENT AND INSTALLATION DETAILS ON SHEETS C302 AND C303
- (14) PROTECT EXIST CURB
- (15) CL STA 20+87.5, REMOVE FULL EXIST SIDEWALK PANEL, MATCH NEW SIDEWALK
- (13) PROTECT EXIST UTILITY VAULT

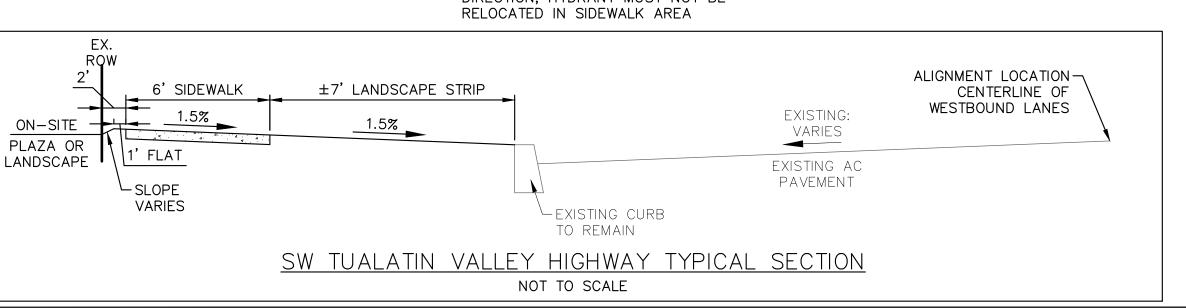

OREGON

EXPIRES: 06/30/25 SIGNATURE DATE: __

© AXIS DESIGN GROUP THESE DRAWINGS ARE THE PROPERTY OF AXIS DESIGN GROUP AND ARE NOT TO BE REPRODUCED IN ANY MANNER EXCEPT WITH THE PRIOR WRITTEN APPROVAL OF AXIS



DESIGNGROUP 11104 S.E. STARK STREET PORTLAND, OR 97216 T: 503.284.0988 | F: 503.546.9276

FIRWOOD 359 E. HISTORIC COLUMBIA RIVER HWY TROUTDALE, OREGON 97060

(503) 668-3737

SW VOL NEW

No.	Descr	ription	
1			
2			
3			
4			
5			
DRAV	VN BY:	ВВ	
CHEC	KED BY:	KG	
IOB N	IO: E20-	-030	
	: 7/26/2		

OF 26

TV HWY PLAN



EXPIRES: 06/30/2 SIGNATURE DATE: _____

© AXIS DESIGN GROUP
THESE DRAWINGS ARE THE PROPERTY OF
AXIS DESIGN GROUP AND ARE NOT TO BE
REPRODUCED IN ANY MANNER EXCEPT WITH
THE PRIOR WRITTEN APPROVAL OF AXIS
DESIGN GROUP.



DESIGNGROUP ARCHITECTURE & ENGINEERING, INC. 11104 S.E. STARK STREET PORTLAND, OR 97216 T: 503.284.0988 | F: 503.546.9276

FIRWOOD
DESIGN GROUP
Reliable Engineering Solutions
359 E. HISTORIC COLUMBIA RIVER HWY
TROUTDALE, OREGON 97060
(503) 668-3737

HERZOG MEIER
VOLKSWAGEN-VOLVO
EW SERVICE BUILDING

No.	Descr	iption	
1			
2			
3			
4			
5			
6			
DRAWN	N BY:	ВВ	
	N BY: ED BY:		

JOB NO: E20-030

DATE: 7/26/2024

SHEET TITLE

.....

ISSUED FOR: LAND USE REVIEW

CR RAMP PROXIMITY
PLAN SW TV HWY

SHEET NO.

C203



EXPIRES: 06/30/25
SIGNATURE DATE: _____

© AXIS DESIGN GROUP
THESE DRAWINGS ARE THE PROPERTY OF
AXIS DESIGN GROUP AND ARE NOT TO BE
REPRODUCED IN ANY MANNER EXCEPT WITH
THE PRIOR WRITTEN APPROVAL OF AXIS
DESIGN GROUP.



DESIGNGROUP ARCHITECTURE & ENGINEERING, INC. 11104 S.E. STARK STREET PORTLAND, OR 97216 T: 503.284.0988 | F: 503.546.9276



ER YOLVO ILDING

HERZOG MEIER
VOLKSWAGEN-VOLN
NEW SERVICE BUILDI
A275 SW 139TH WAY
BEAVERTON, OR 97005


No.	Description	n Dat
1		
2		
3		
4		
5		
6		
DRAW	N BY: BB	
CHECK	(ED BY: KG	
JOB N	O: E20-030	


SHEET NO.


SHEET TITLE


C204

CR SPOT GRADING AT SW TV HWY

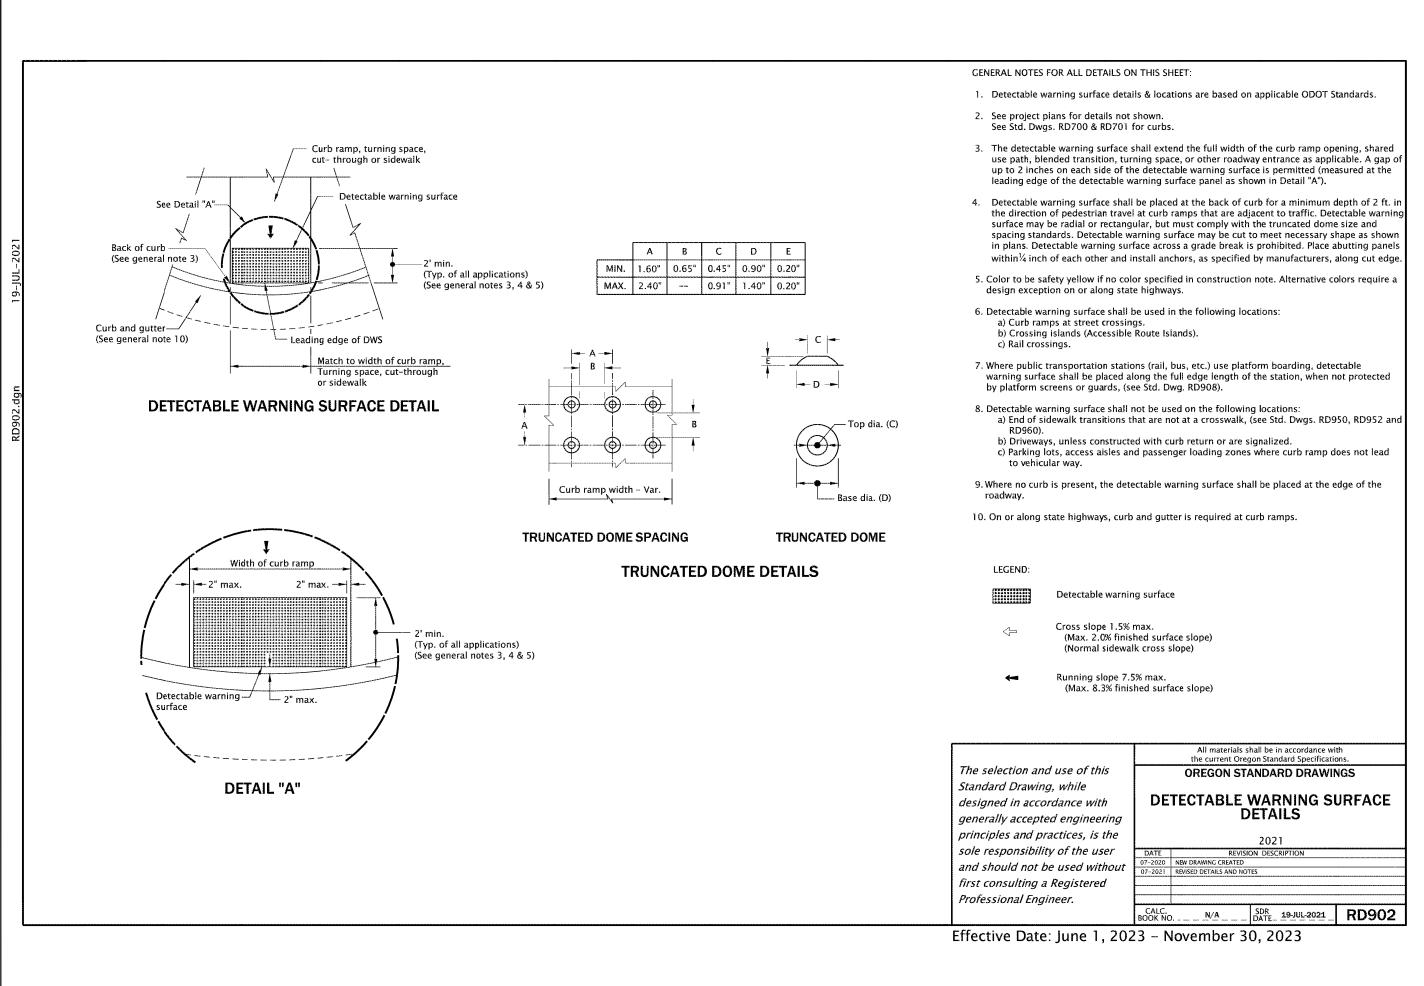

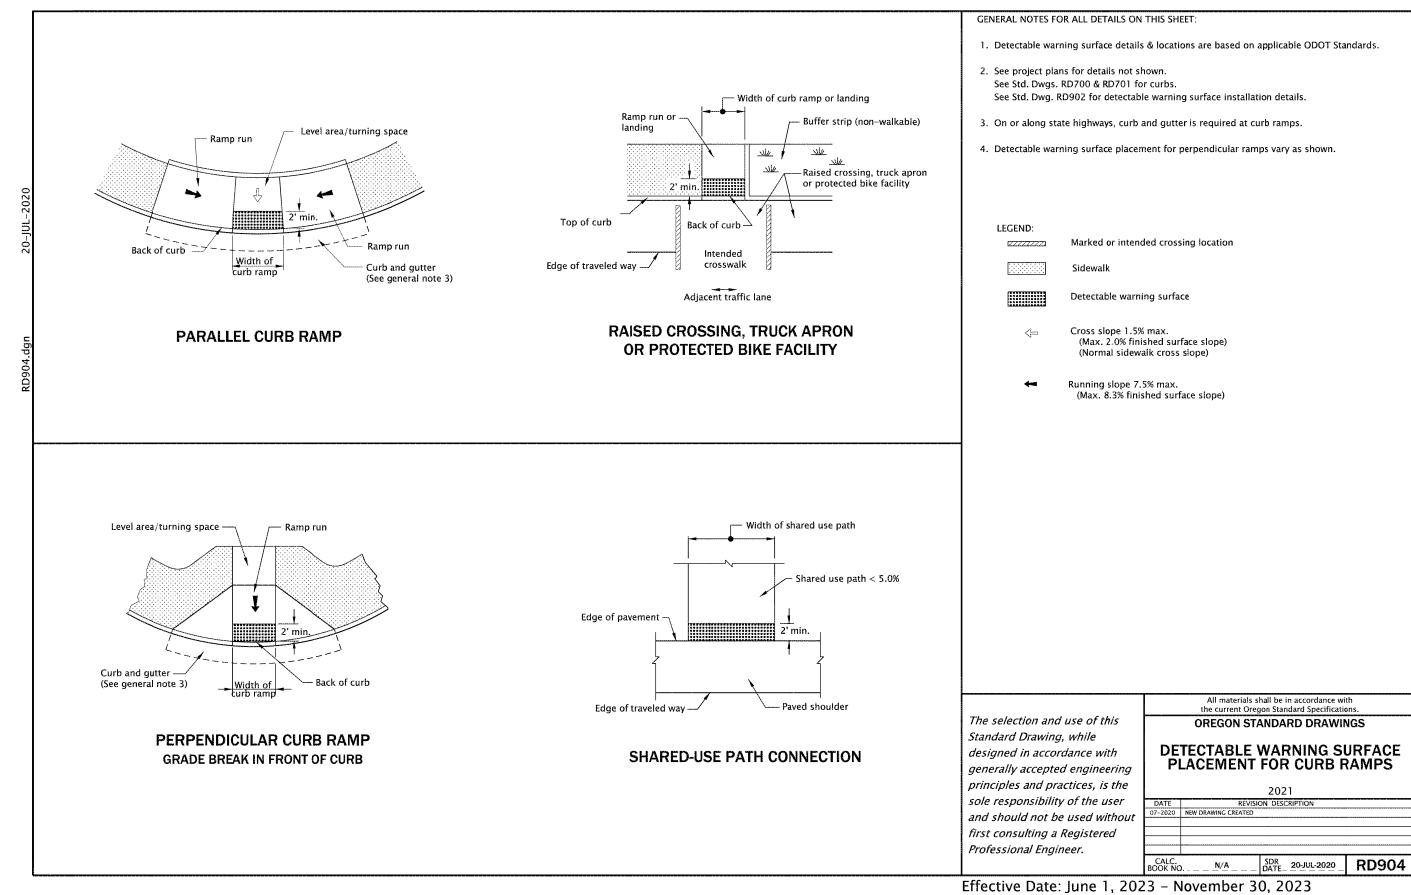

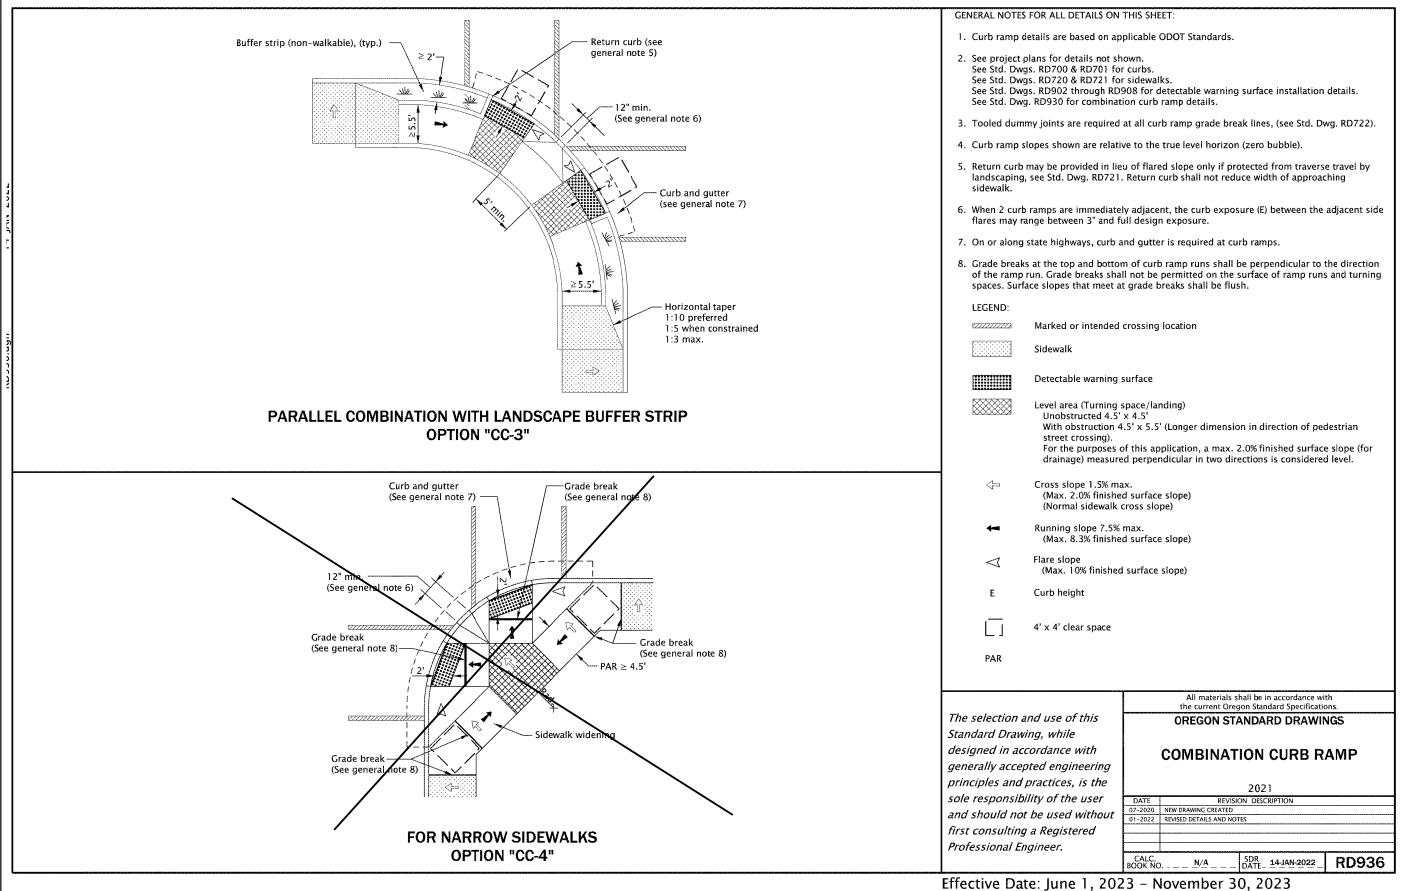

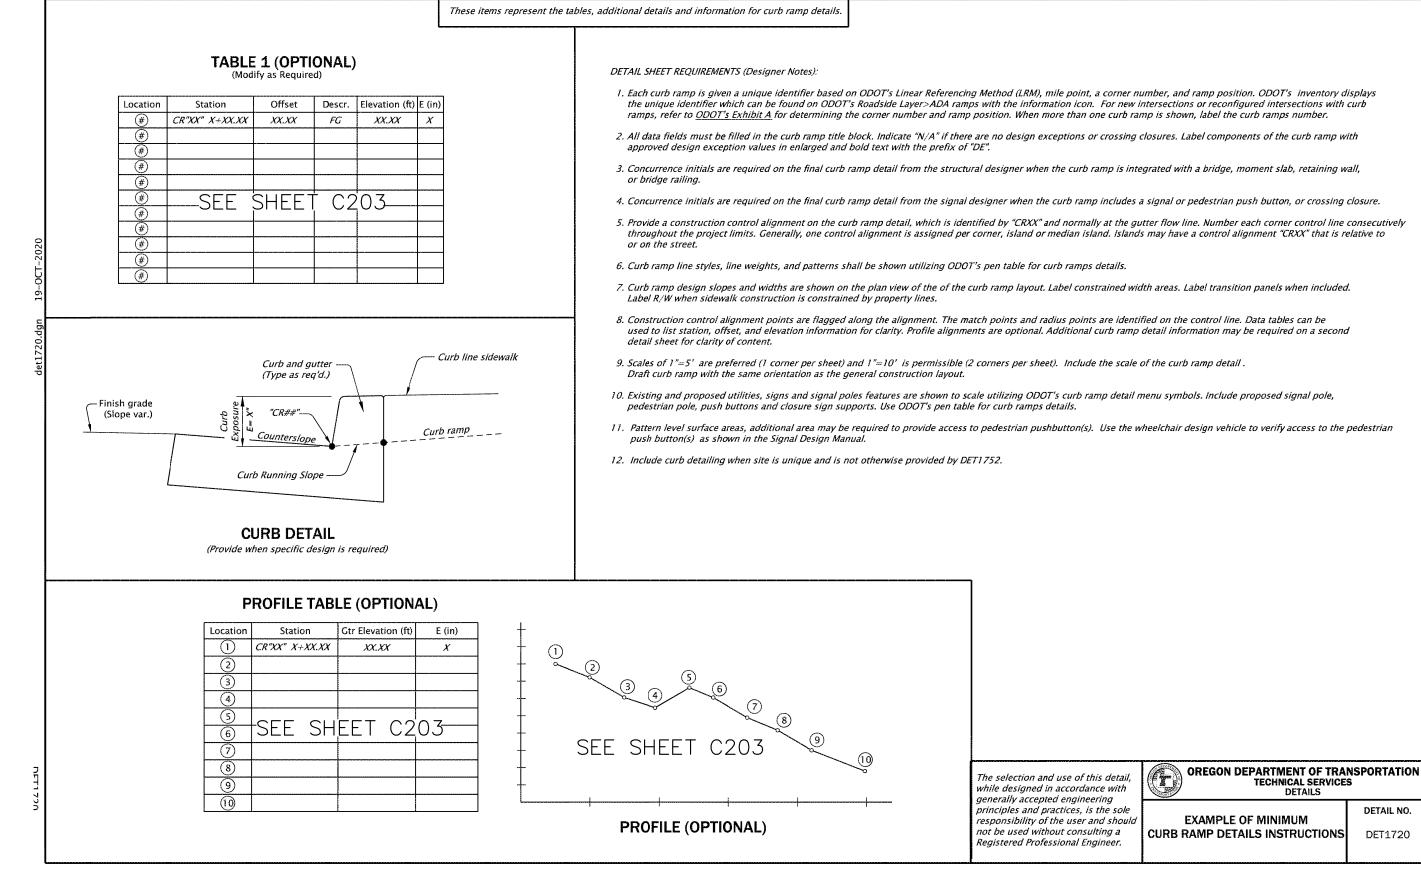

67149PE
PRELIMINARY
OREGON

7. 14, 200 167

EXPIRES: 06/30/25
SIGNATURE DATE: _____

© AXIS DESIGN GROUP
THESE DRAWINGS ARE THE PROPERTY OF
AXIS DESIGN GROUP AND ARE NOT TO BE
REPRODUCED IN ANY MANNER EXCEPT WITH
THE PRIOR WRITTEN APPROVAL OF AXIS
DESIGN GROUP.



DESIGNGROUP ARCHITECTURE & ENGINEERING, INC 11104 S.E. STARK STREET PORTLAND, OR 97216 T: 503.284.0988 | F: 503.546.9276




(503) 668-3737


HERZOG MEIER OLKSWAGEN-VOLVO :W SERVICE BUILDING A275 SW 139TH WAY BEAVERTON, OR 97005


REVIS	IONS		
No.	Descr	iption	Date
1			
2			
3			
4			
5			
DRAV	VN BY:	BB	
CHEC	KED BY:	KG	
JOB N	IO: E20-	030	
DATE	: 7/26/2	024	
ISSUE	D FOR: LA	AND USE F	REVIEW
SHEE	T TITLE		
	DOT D	ETAIL	S 1
-			


SHEET NO.

C300

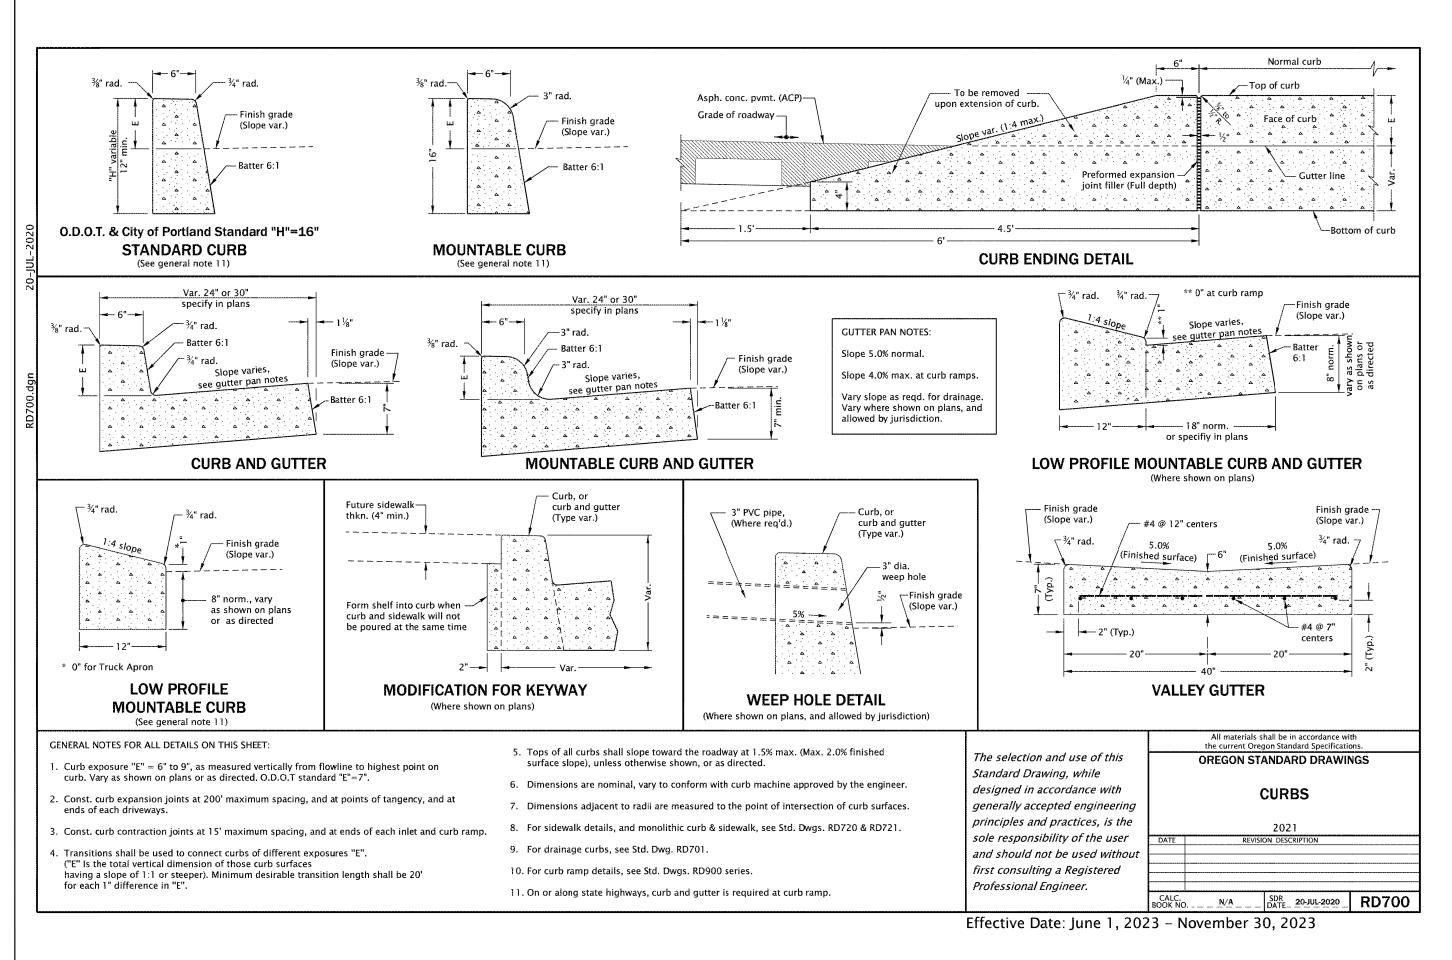

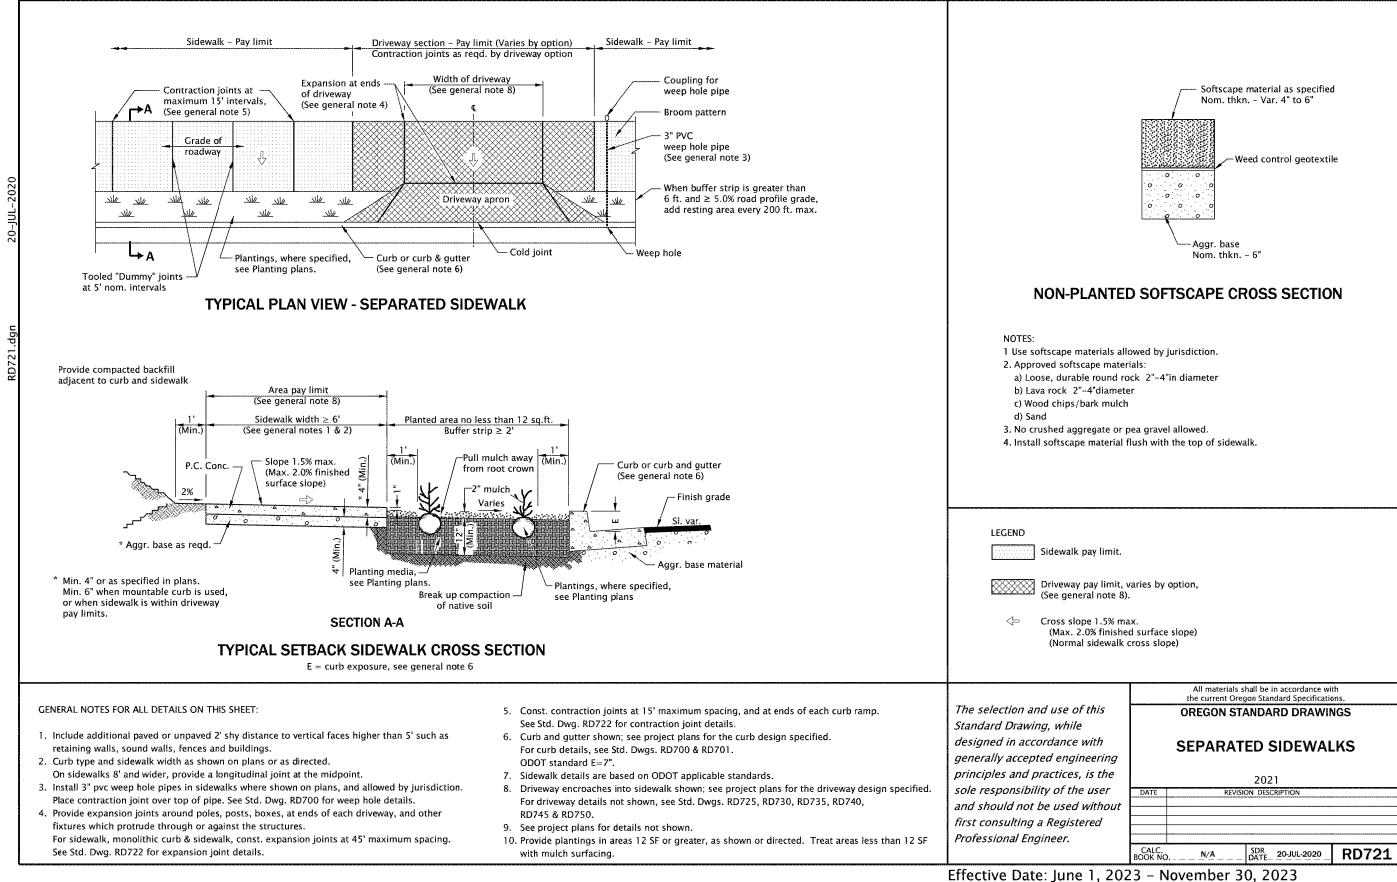

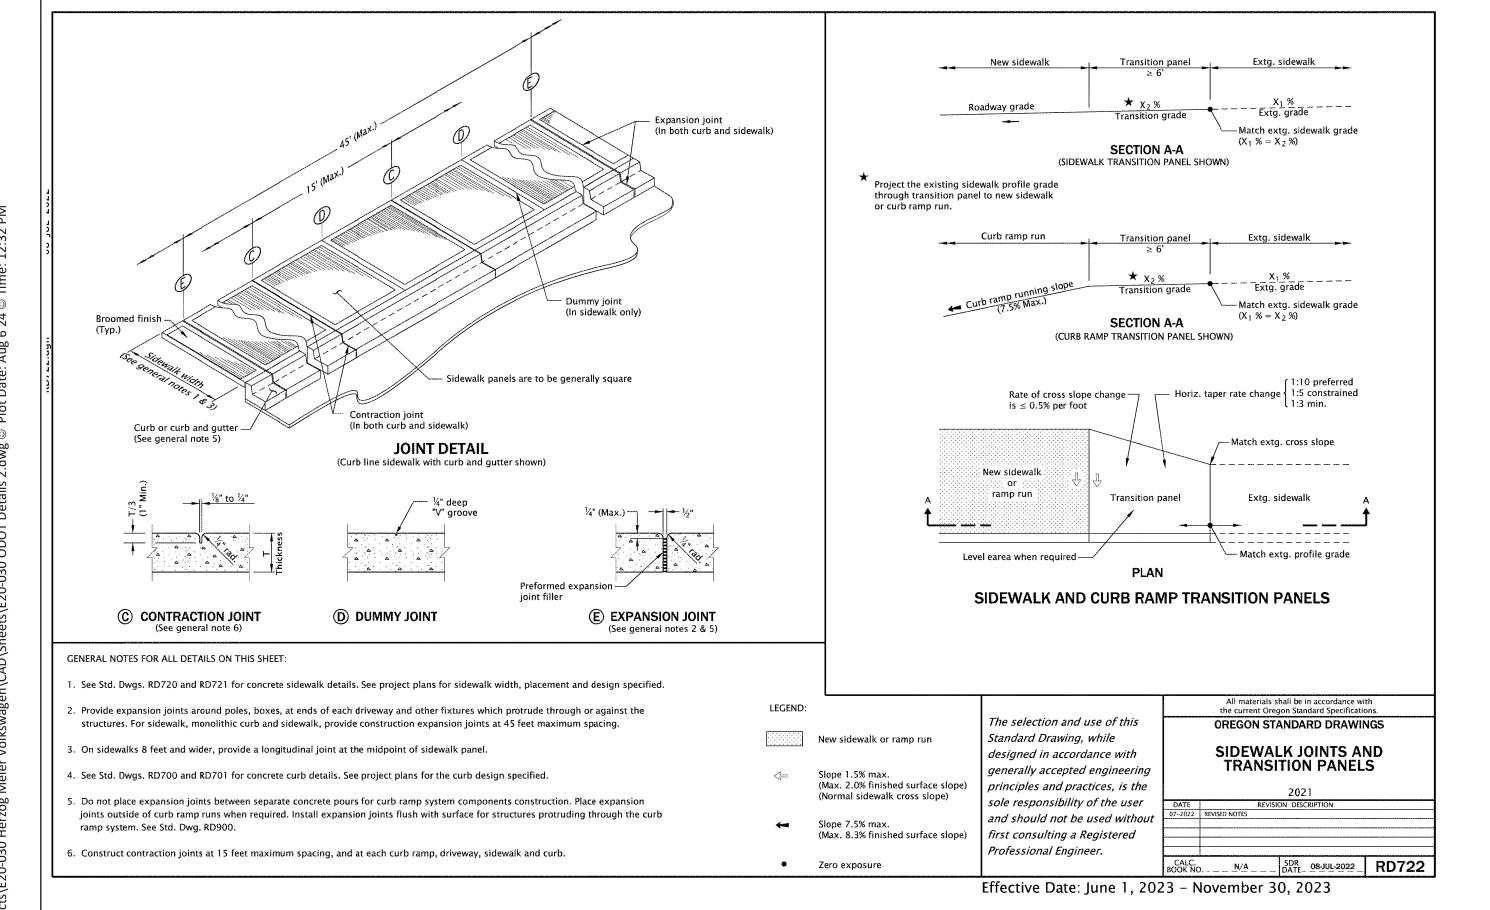


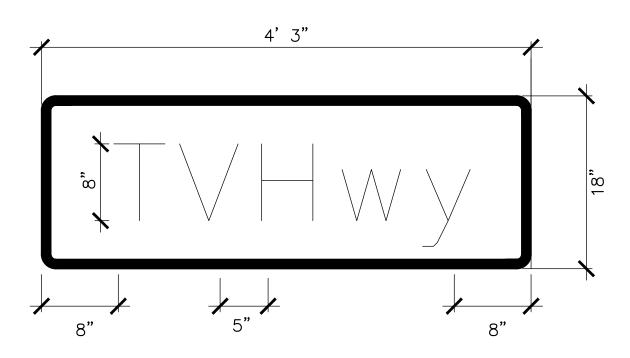

SIGN DATA:

- ALUMINUM SIGN SUBSTRATE
- ASTM TYPE III SHEETING8" WHITE 'C' LEGEND ON GREEN BACKGROUND
- 1" BOARDER FLUSH WITH EDGE OF SIGN


"TV Hwy" FACING TV HIGHWAY DETAIL

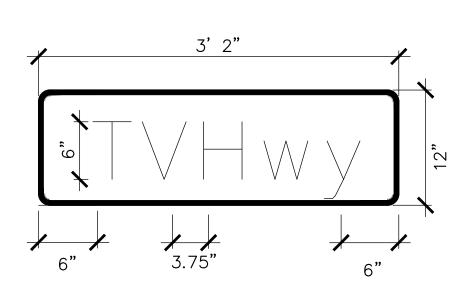

SIGN DATA:

- ALUMINUM SIGN SUBSTRATE
 ACTIVITY TYPE III CHIEFTING
- ASTM TYPE III SHEETING
- 6" WHITE 'C' LEGEND ON GREEN BACKGROUND
 1/2" BOARDER FLUSH WITH EDGE OF SIGN

"TV Hwy" FACING SW 139TH WAY DETAIL

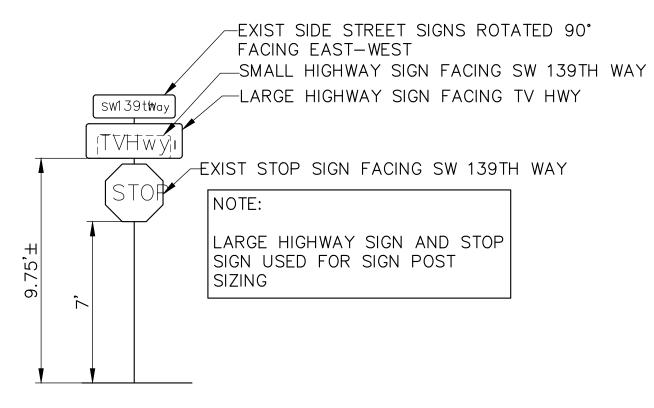

SIGN TREE DETAIL FACING INTO SW 139TH WAY

67149PE
PRELIMINARY
OREGON
TO 14, 200 CC
A. GRO

EXPIRES: 06/30/25
SIGNATURE DATE: _____

© AXIS DESIGN GROUP
THESE DRAWINGS ARE THE PROPERTY OF
AXIS DESIGN GROUP AND ARE NOT TO BE
REPRODUCED IN ANY MANNER EXCEPT WITH
THE PRIOR WRITTEN APPROVAL OF AXIS
DESIGN GROUP.



DESIGNGROUP ARCHITECTURE & ENGINEERING, INC. 11104 S.E. STARK STREET PORTLAND, OR 97216 T: 503.284.0988 | F: 503.546.9276





HERZOG MEIER VOLKSWAGEN-VOLVO IEW SERVICE BUILDING


No.	Description	Da
2		
3		+
4		+-
5		+
6		
		-
		+
		+
DRAV	VN BY: BB	
CHEC	KED BY: KG	
IOR I	NO: E20-030	
,001	VO: L20 030	
	: 7/26/2024	
DATE		
DATE	. //20/2024	
	D FOR: LAND USE R	E) //E) A


C30

SHEET NO.

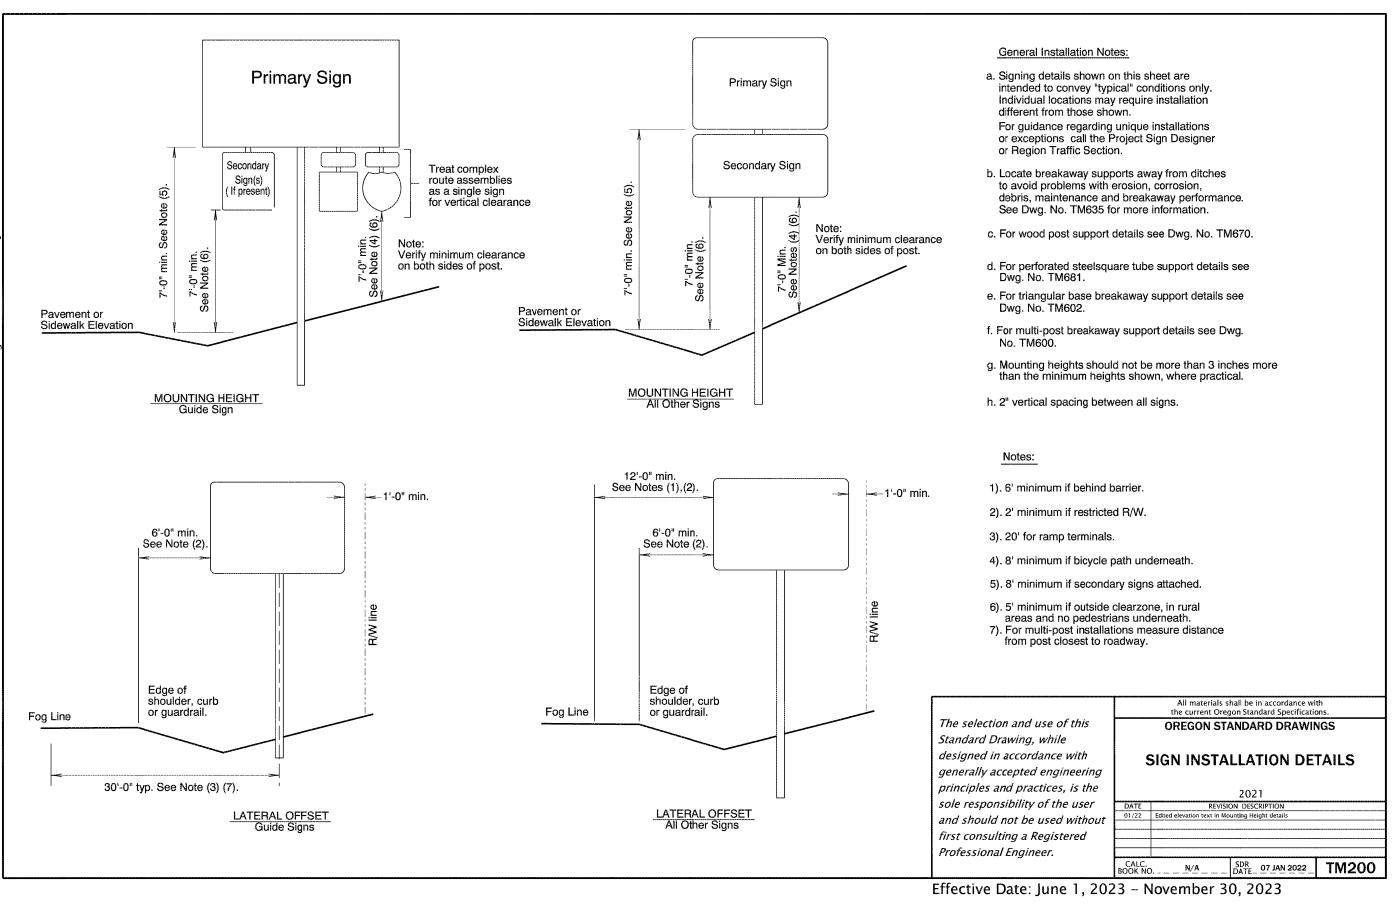

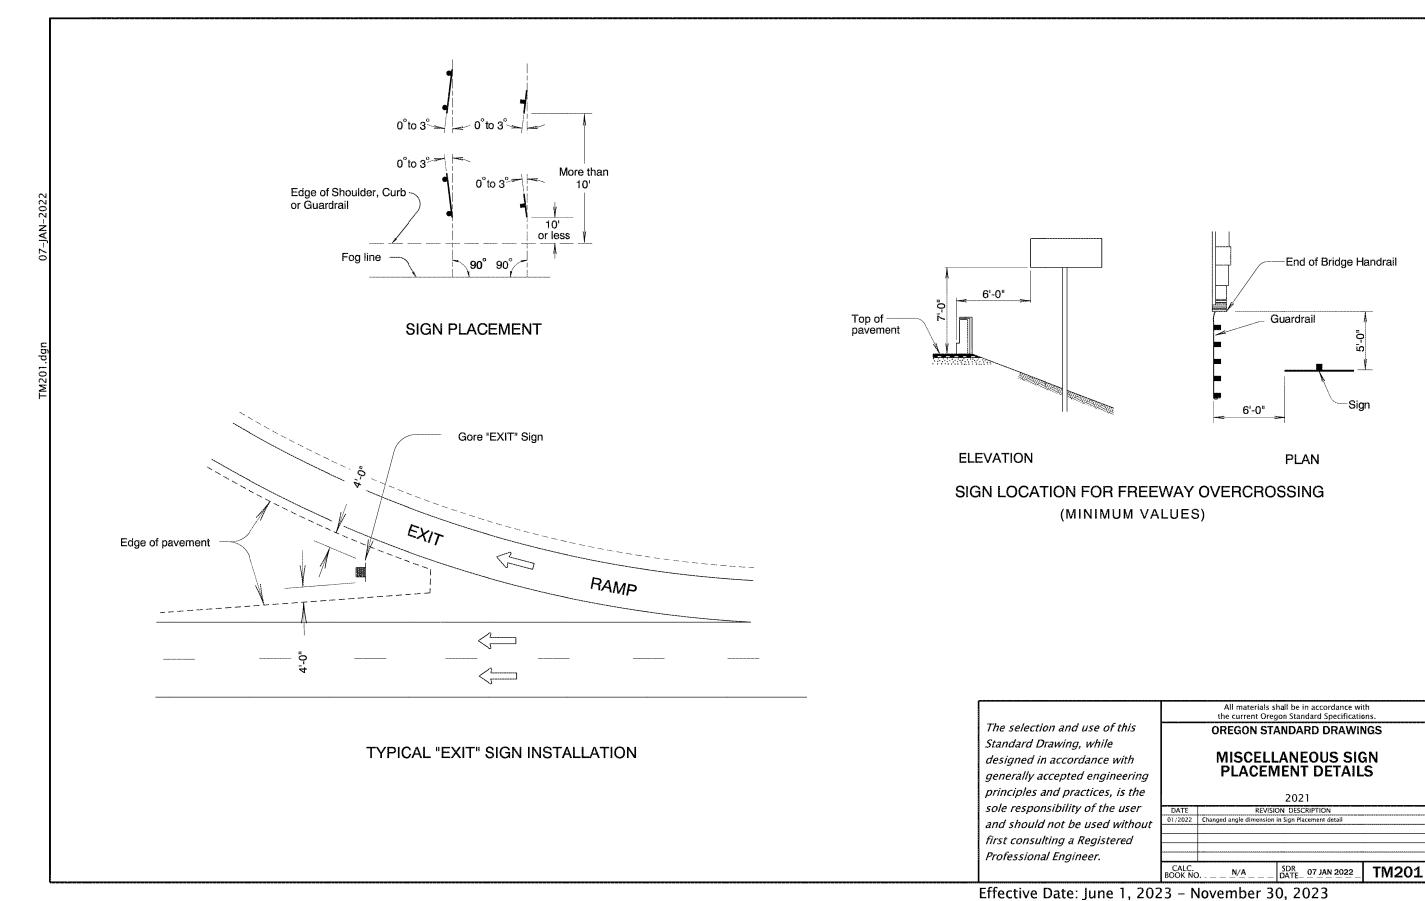

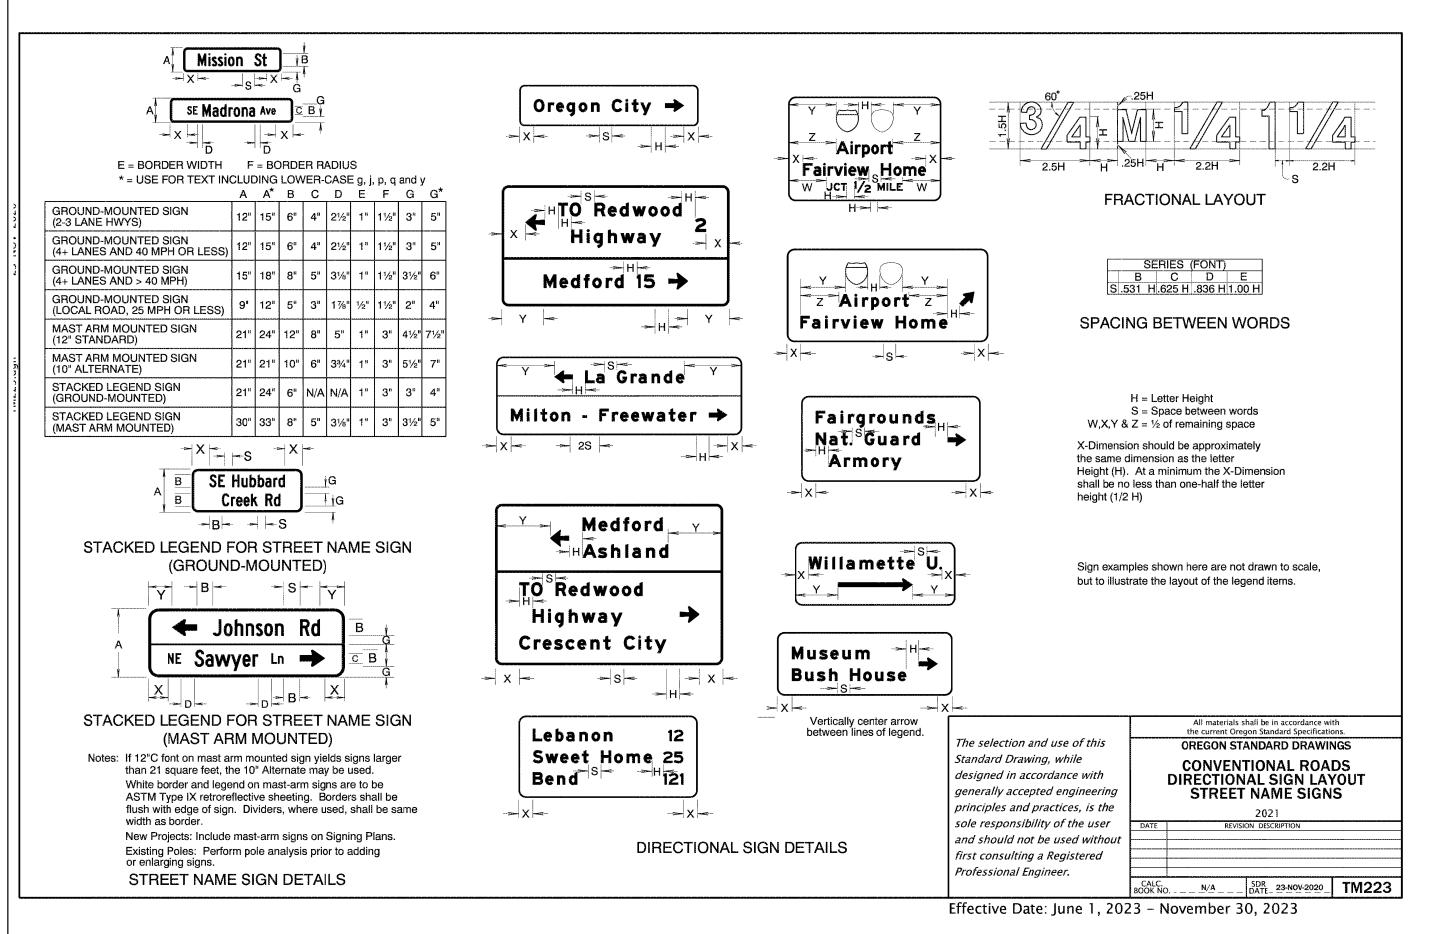

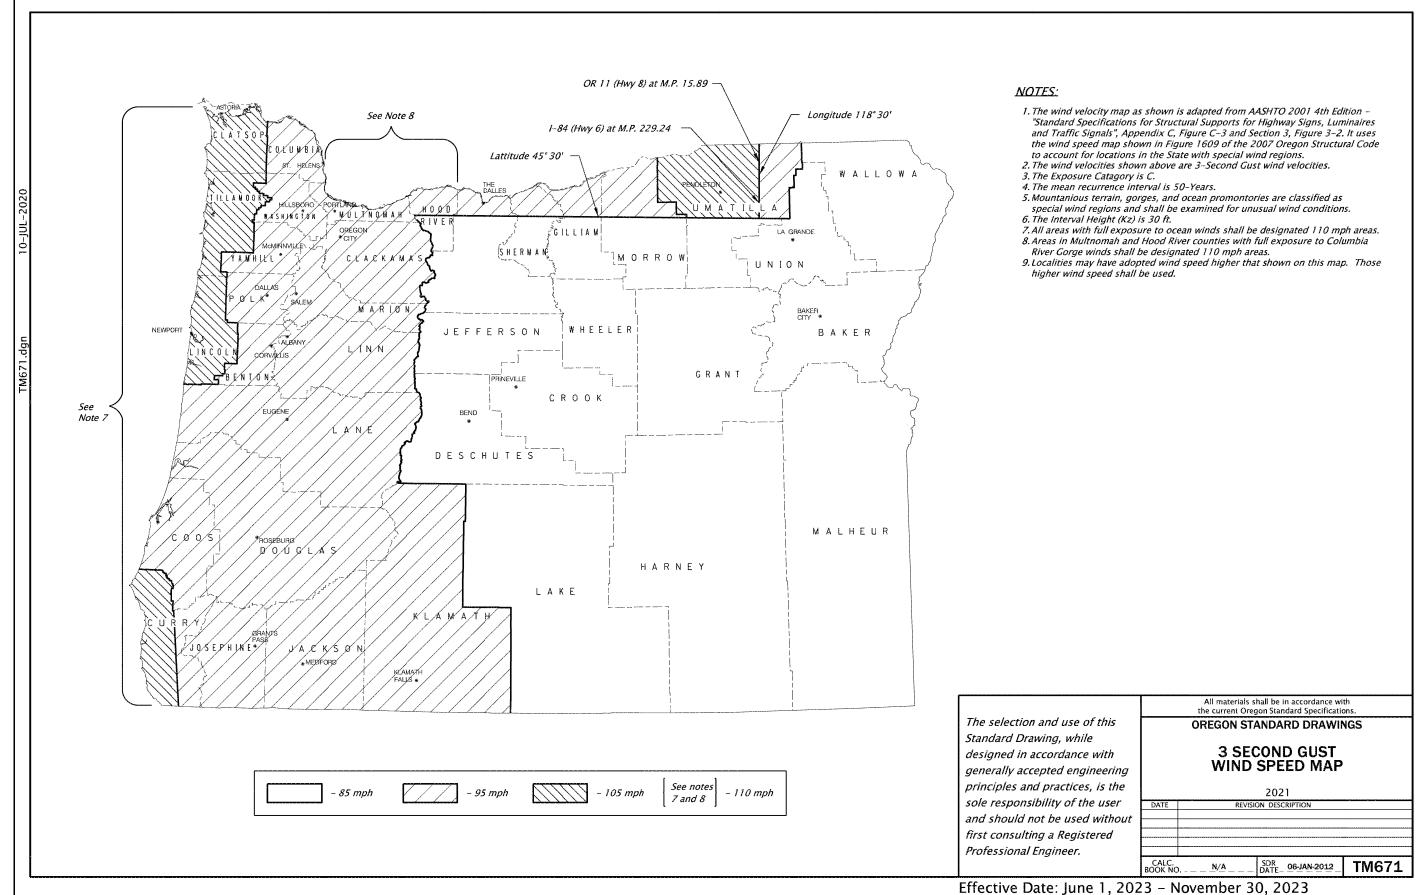

PRELIMINARY
OREGON

FXPIRES: 06/30/25

EXPIRES: 06/30/25
SIGNATURE DATE: _____

© AXIS DESIGN GROUP
THESE DRAWINGS ARE THE PROPERTY OF
AXIS DESIGN GROUP AND ARE NOT TO BE
REPRODUCED IN ANY MANNER EXCEPT WITH
THE PRIOR WRITTEN APPROVAL OF AXIS
DESIGN GROUP.



DESIGNGROUP ARCHITECTURE & ENGINEERING, INC. 11104 S.E. STARK STREET PORTLAND, OR 97216 T: 503.284.0988 | F: 503.546.9276

FIRWOOD
DESIGN GROUP
Reliable Engineering Solutions
359 E. HISTORIC COLUMBIA RIVER HWY
TROUTDALE, OREGON 97060


(503) 668-3737


HERZOG MEIER VOLKSWAGEN-VOLVO NEW SERVICE BUILDING 4275 SW 139TH WAY BEAVERTON, OR 97005


No.	Description	Date
1	Везопрелоп	Date
2		
3		
4		
5		
6		
DRAW	N BY: BB	
~	ED BY: KG	
CHECK	EDDI. KO	
	D: E20-030	
JOB NO	D: E20-030	
JOB NO		
JOB NO	7/26/2024	
JOB NO	D: E20-030	EVIEW
DATE:	D: E20-030 7/26/2024 D FOR: LAND USE R	EVIEW
DATE: SSUEC	7/26/2024 FOR: LAND USE R	
DATE: SSUEC	7/26/2024 FOR: LAND USE R	
DATE: SSUEC	D: E20-030 7/26/2024 D FOR: LAND USE R	

SHEET NO.

C302

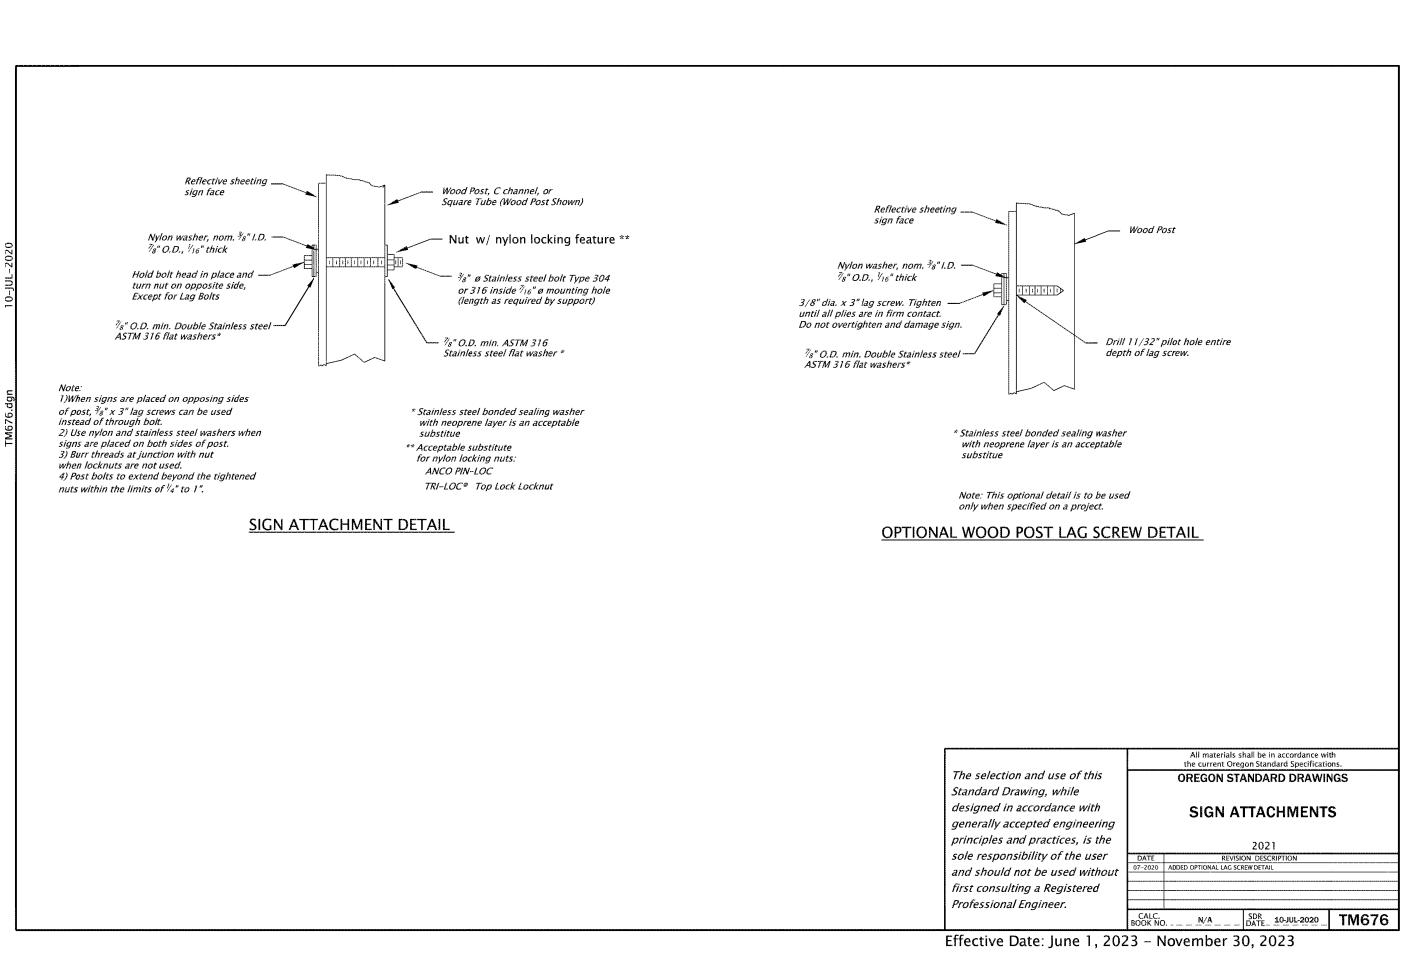

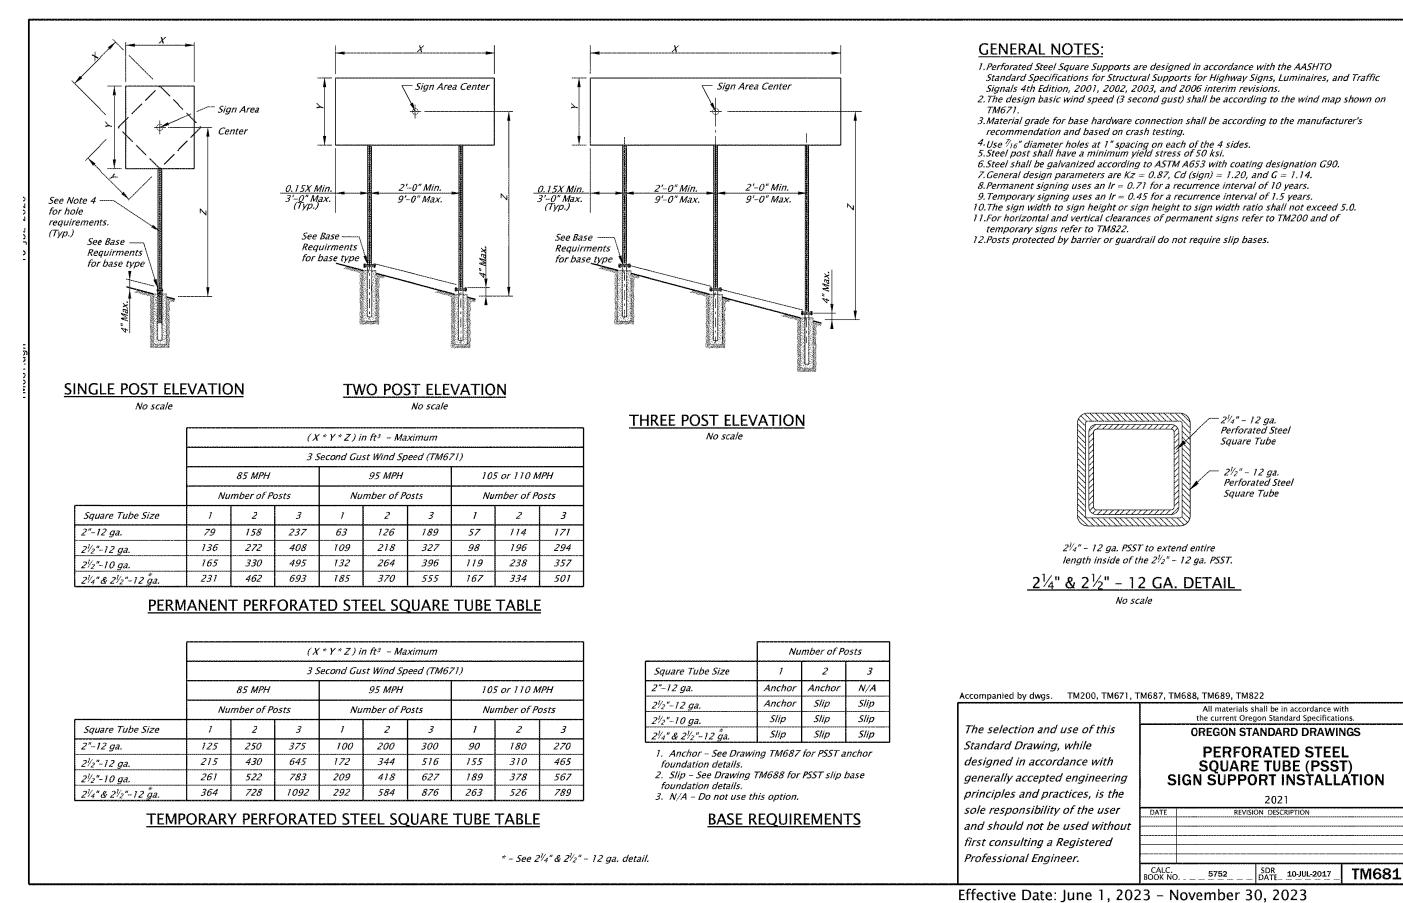

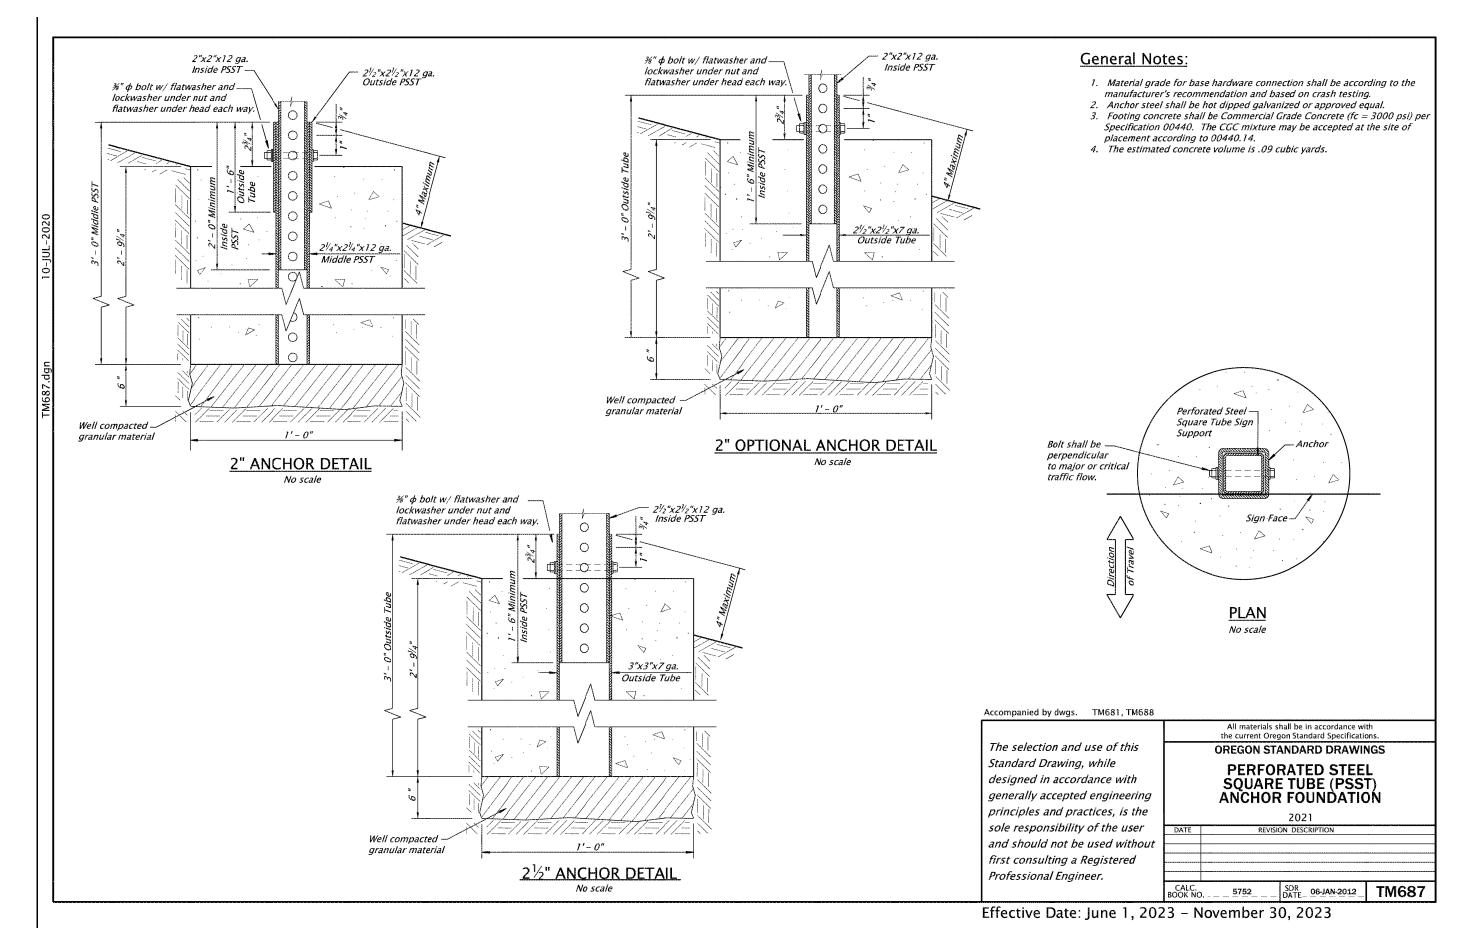



EXPIRES: 06/30/25 SIGNATURE DATE: _____

© AXIS DESIGN GROUP
THESE DRAWINGS ARE THE PROPERTY OF
AXIS DESIGN GROUP AND ARE NOT TO BE
REPRODUCED IN ANY MANNER EXCEPT WITH
THE PRIOR WRITTEN APPROVAL OF AXIS
DESIGN CROUP



DESIGNGROUP ARCHITECTURE & ENGINEERING, INC. 11104 S.E. STARK STREET PORTLAND, OR 97216 T: 503.284.0988 | F: 503.546.9276





HERZOG MEIER
VOLKSWAGEN-VOLVO
IEW SERVICE BUILDING
A275 SW 139TH WAY
BEAVERTON, OR 97005


No.	Description	Date
1	Beschiption	Date
2		
3		
4		
5		
6		
-		
\rightarrow		
		1
DRAW	/N BY: BB	
CHEC	KED BY: KG	
	O: E20-030	
IOB IV	O. L20-030	
	7/26/2024	
JAIL.	7/26/2024	
SSUE	D FOR: LAND USE R	EVIEW
пес	TITLE	
חבב		
	DOT DETAILS	54


SHEET NO.

C303

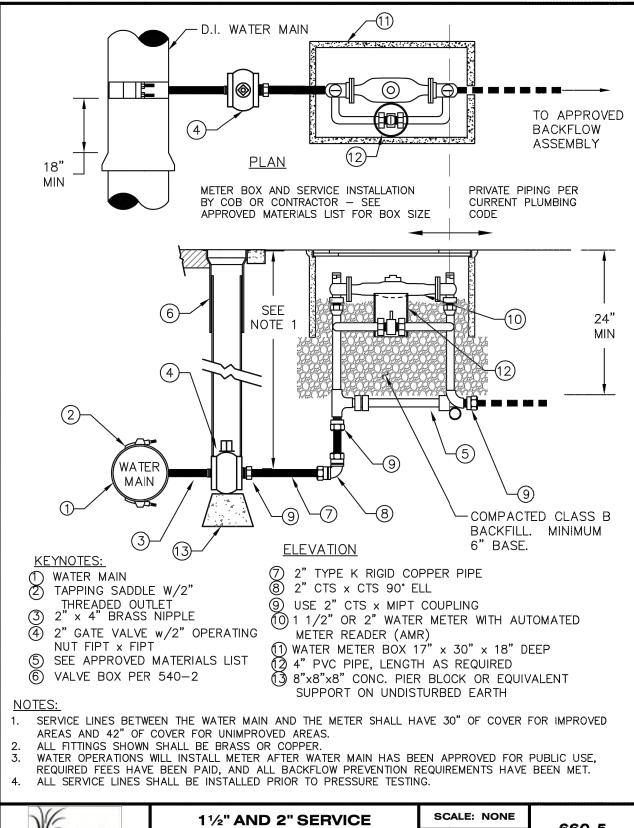

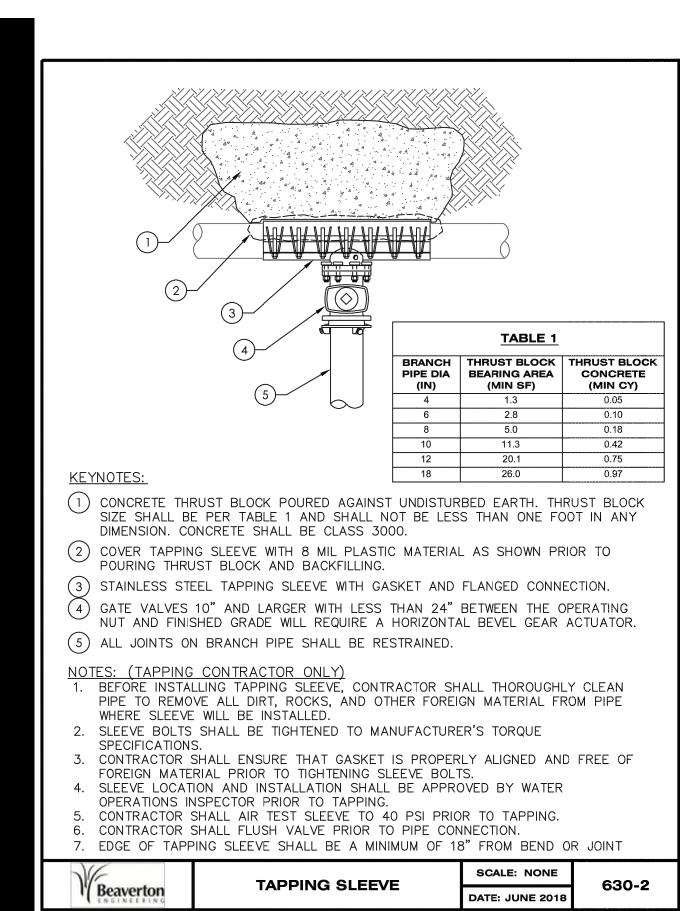

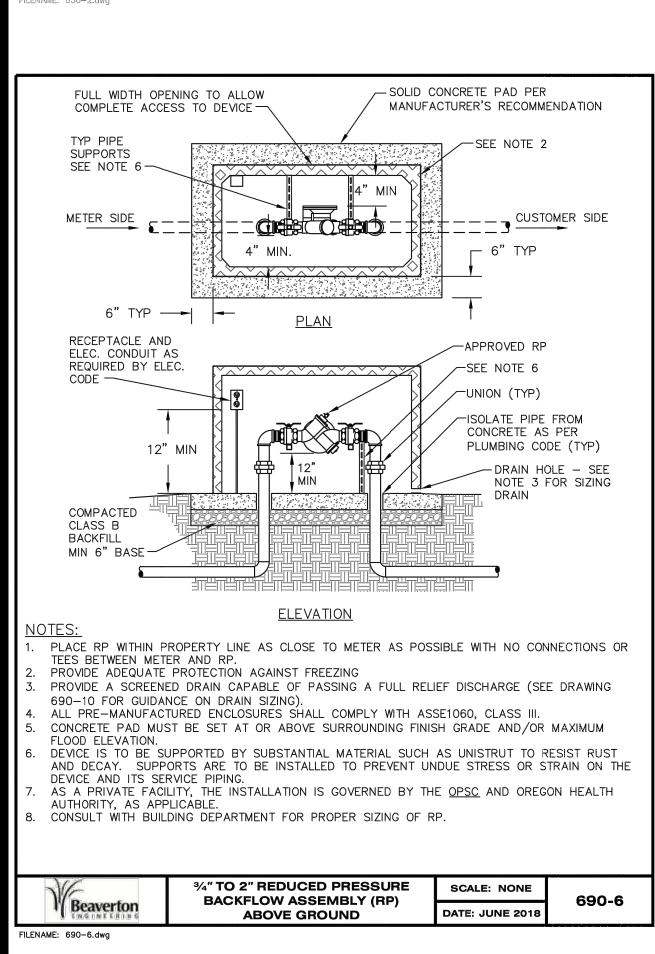

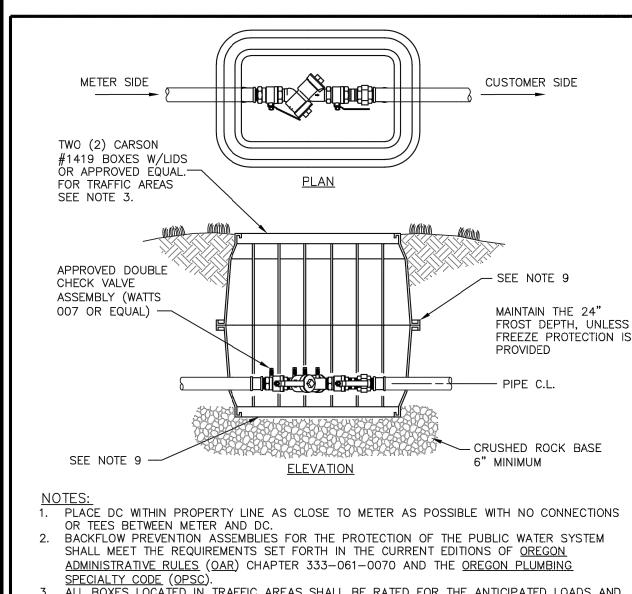

SPECIALTY CODE (OPSC).
ALL BOXES LOCATED IN TRAFFIC AREAS SHALL BE RATED FOR THE ANTICIPATED LOADS AND

FURNISHED WITH APPROVED TRAFFIC-RATED COVERS. DC'S SHALL BE READILY ACCESSIBLE WITH ADEQUATE SPACE FOR TESTING AND MAINTENANCE. PROVIDE AT LEAST 6 INCHES OF CLEARANCE ON BOTH SIDES AND BELOW WHEN THE DC IS INSTALLED BELOW GROUND, THE TEST PORTS MUST NOT FACE DOWNWARD.


TEST PORTS MUST BE PROVIDED WITH PLASTIC OR BRASS PLUGS. THE DC SHALL BE INSTALLED AT A DEPTH OF 24 INCHES BELOW GROUND. IF FREEZE PROTECTION IS PROVIDED, THE 24 INCH DEPTH MAY BE REDUCED.


CONTACT CITY OF BEAVERTON BUILDING DEPARTMENT FOR THE REQUIRED PLUMBING PERMIT. UPON COMPLETION OF INSTALLATION, THE DC MUST BE TESTED BY A STATE CERTIFIED

BACKFLOW TESTER.


CONNECT BOXES TOGETHER WITH CORROSION—RESISTANT FASTENERS TO FORM A SINGLE ENCLOSURE. SECURE THE LID OF THE LOWER BOX TO PREVENT DEBRIS FROM ENTERING. 10. CONSULT WITH BUILDING DEPARTMENT FOR PROPER SIZING OF DC.

WE.	3/4" OR 1" DOUBLE CHECK VALVE ASSEMBLY (DC)	SCALE: NONE	690-3A
l'(Beaverton	VALVE ASSEMBLY (DC)	DATE: JUNE 2018	690-3A
ILENAME: 690–3A.dwg			

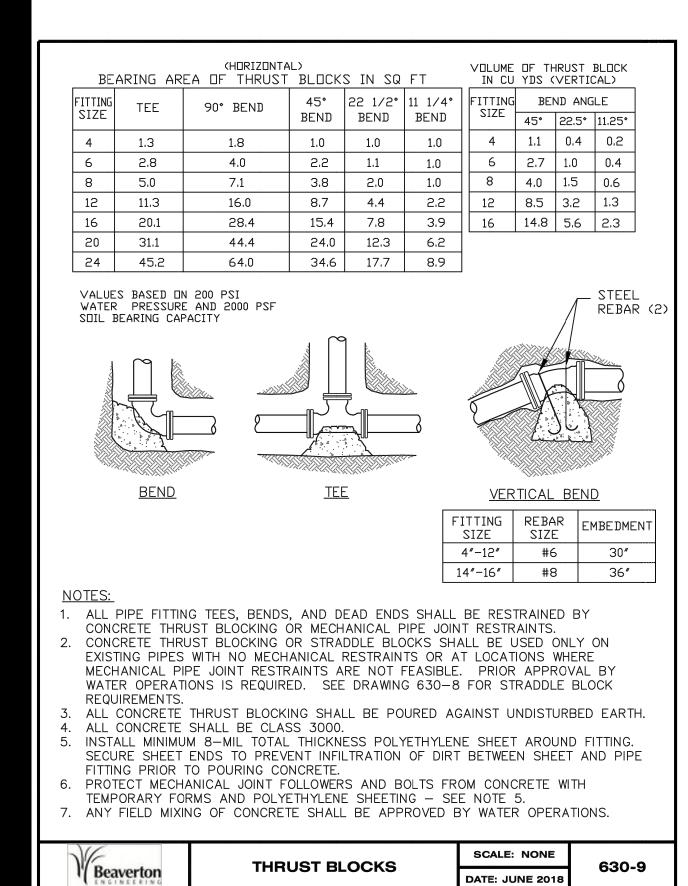

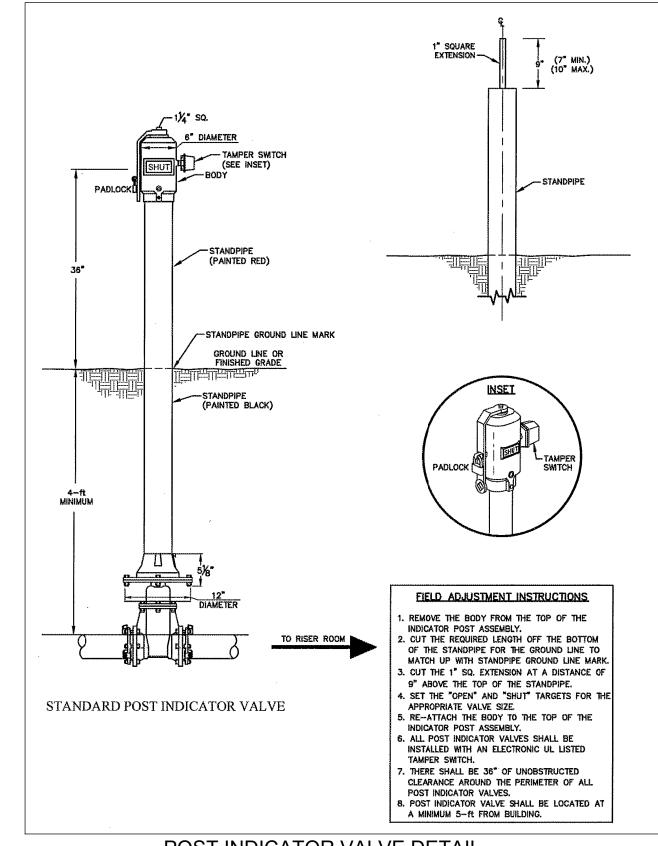

POST INDICATOR VALVE DETAIL SCALE: NTS

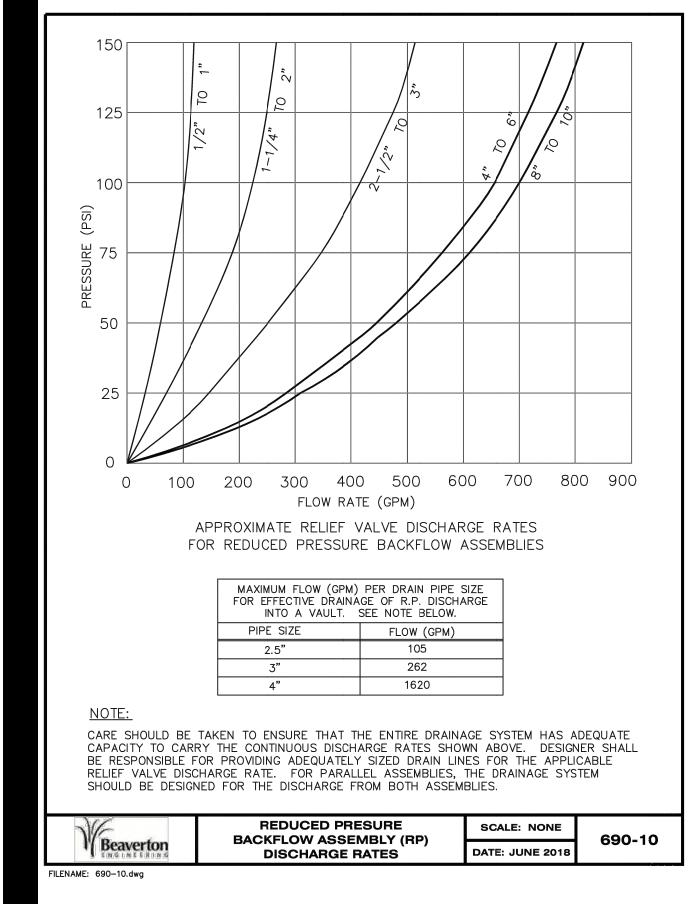



EXPIRES: 06/30/25 SIGNATURE DATE: __

© AXIS DESIGN GROUP THESE DRAWINGS ARE THE PROPERTY OF AXIS DESIGN GROUP AND ARE NOT TO BE REPRODUCED IN ANY MANNER EXCEPT WITH THE PRIOR WRITTEN APPROVAL OF AXIS



DESIGNGROUP 11104 S.E. STARK STREET PORTLAND, OR 97216 T: 503.284.0988 | F: 503.546.9276

FIRWOOD Reliable Engineering Solutions 359 E. HISTORIC COLUMBIA RIVER HWY TROUTDALE, OREGON 97060 (503) 668-3737

MEIER EN-VOLVO E BUILDING Oď SW SER VOL NEW

REVISIONS

Description DRAWN BY: BB CHECKED BY: KG JOB NO: E20-030 DATE: 7/26/2024 ISSUED FOR: LAND USE REVIEW SHEET TITLE WATER DETAILS

C304

SHEET NO.

OF 26

Beaverton ENAME: 660-5.dwg

CONNECTION

DATE: JUNE 201

FILENAME: 630-9.dwg





FILENAME: 690-5B.dwg

•LAWN GRASS

• GROUND COVER

BARKDUST

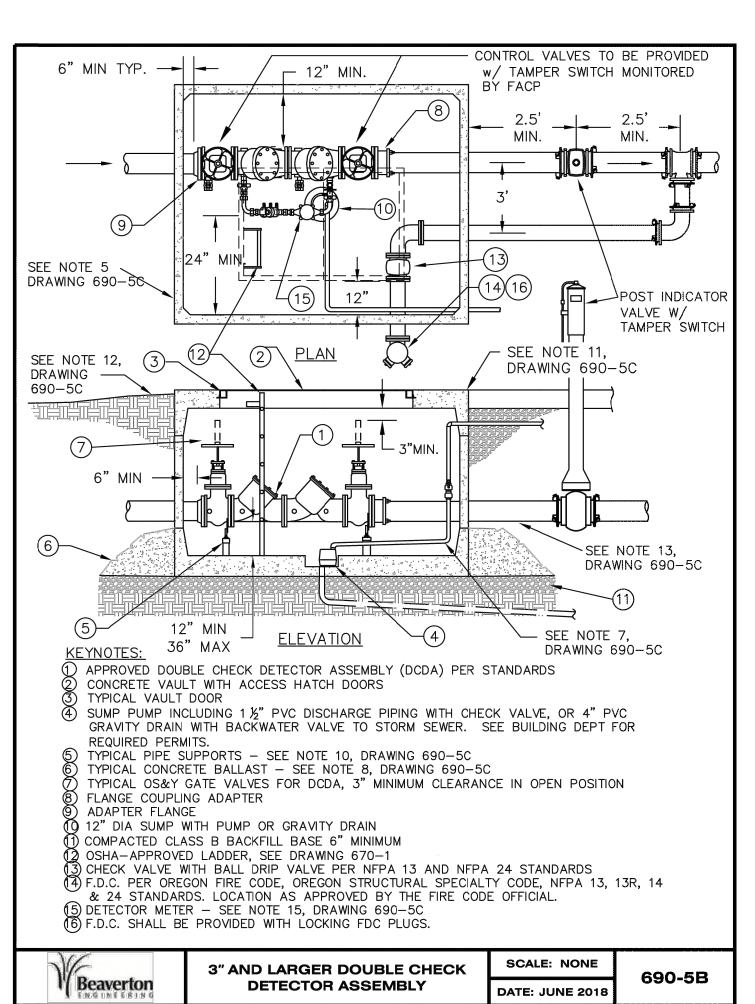

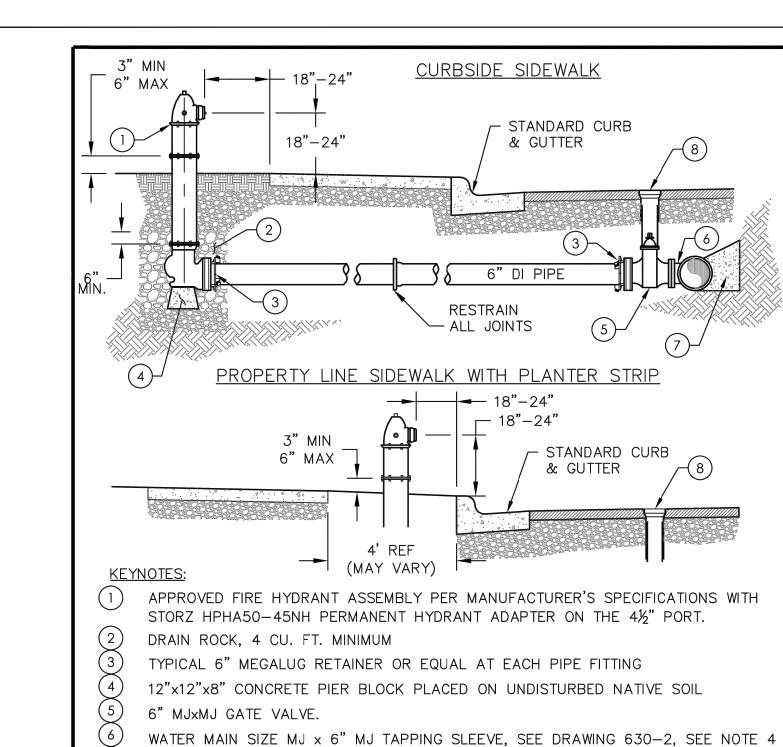

CONCRETE THRUST BLOCK, SEE DRAWING 630-9

1. REFER TO DRAWING 650-1 FOR HYDRANT CLEAR ZONE REQUIREMENTS

VALVE BOX, SEE DRAWING 640-2

2. HYDRANT BURY DEPTH - 30" MIN., 6' MAX.

РАТН.			
VE	FIRE HYDRANT ASSEMBLY	SCALE: NONE	650-2
V Beaverton	INSTALLATION	DATE: JUNE 2018	

4. USE MJ OR FLG VALVE & TEE AS NEEDED TO PLACE VALVE BOX OUTSIDE OF WHEEL

3. WHEN FINAL LIFT OF HMAC IS PLACED, CONTRACTOR TO SET A BLUE REFLECTOR

BUTTON FOR THE FIRE DEPARTMENT. SEE DRAWING 650-4 FOR PLACEMENT

VAULT INFORMATION DCVA OLDCASTLE DOOR MODEL SIZE VAULT NO. 676-WA 676-T-2-332P 687-WA 687-T-2-332P 5106-WA 5106-3-T-2-332P 10" 5106-WA 5106-3-T-2-332P OR APPROVED EQUAL

GENERAL NOTES:


FILENAME: 650-2.dwg


- CONSULT WITH FIRE DEPARTMENT FOR SIZING OF DCDA.
- 2. THIS IS TO BE A PRIVATE FACILITY, GOVERNED BY OPSC, NFPA, OREGON HEALTH AUTHORITY, AND
- HILLSBORO FIRE MARSHAL, AS APPLICABLE. 3. ALL MJ JOINTS SHALL HAVE MECHANICAL JOINT RESTRAINTS.
- 4. CONTRACTOR TO SEAL ALL OPENINGS IN VAULT WITH NON-SHRINK GROUT OR "LINK-SEAL."
- 5. COAT ALL EXTERIOR VAULT SURFACES WITH CO-MA-SEAL, OR APPROVED EQUAL.
- PROVIDE POWER SOURCE AS REQUIRED FOR SUMP PUMP. SECURE POWER CORD TO DISCHARGE PIPING WITH NYLON CABLE TIES. SEE DRAWING 670-2 FOR SUMP PUMP INSTALLATION DETAILS.
- 7. PLUMB PUMP DISCHARGE TO APPROVED LOCATION PER PLUMBING INSPECTOR.
- B. IN AREAS PRONE TO HIGH GROUNDWATER POUR CONCRETE BALLAST (3 CUBIC YARDS MINIMUM); ENGINEER IS RESPONSIBLE TO ENSURE ADEQUATE BALLAST IS PROVIDED TO PREVENT FLOATING OF
- 9. VAULT DOOR MECHANISMS SHALL NOT PROTRUDE BELOW THE CEILING OF THE VAULT INTERIOR. 10. ASSEMBLY IS TO BE SUPPORTED BY A SUBSTANTIAL RUST-RESISTANT PRODUCT SUCH AS "STANDON" OR APPROVED EQUAL TO PREVENT UNDUE STRESS OR STRAIN ON THE ASSEMBLY AND
- 11. VAULT TOP SHALL BE SET LEVEL WITH ADJACENT HARD SURFACE (CONCRETE OR AC PAVEMENT).
- 12. FOR INSTALLATION IN LANDSCAPE AREA, PLACE VAULT TOP 3"-5" ABOVE GROUND SURFACE AND SLOPE GROUND AWAY AT 1/4" PER FOOT TYPICAL. DO NOT BURY HATCH DRAIN.
- 13. EXTEND DUCTILE IRON PIPE 5' MINIMUM OUT OF VAULT TO PROTECT FROM BREAKING DUE TO VAULT SETTLEMENT.
- 14. SEE DRAWING 690-5A FOR PLAN AND ELEVATION VIEWS. TYPICAL LAYOUT SHOWN, MAY BE INSTALLED IN OPPOSITE CONFIGURATION TO CONFORM TO SITE CONDITION REQUIREMENTS.
- 15. DETECTOR METER SHALL BE MART & COMPATIBLE WITH SENSUS MX4.
- 16. WHEN LOCATED IN PEDESTRIAN WALKWAY A NON-SLIP LID AND GROUTED PICK HOLES ARE REQUIRED.


690-5C

V	3" AND LARGER DOUBLE CHECK DETECTOR ASSEMBLY	SCALE: NONE
ly Beaverton	(DETAIL NOTES)	DATE: JUNE 2018

FILENAME: 690-5C.dwg

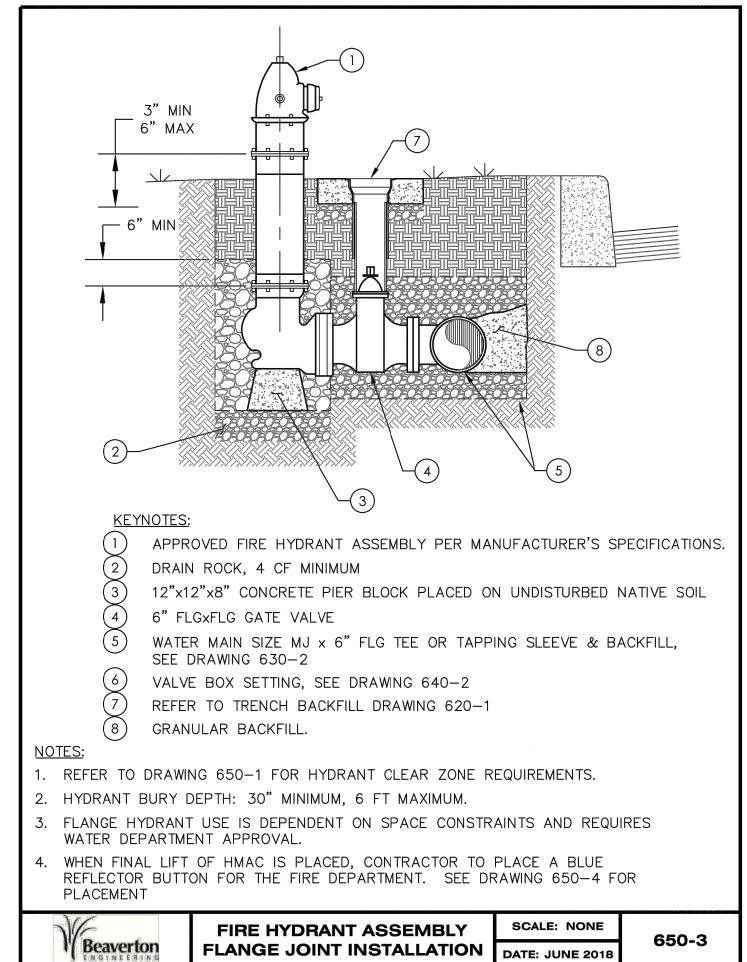

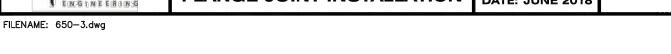

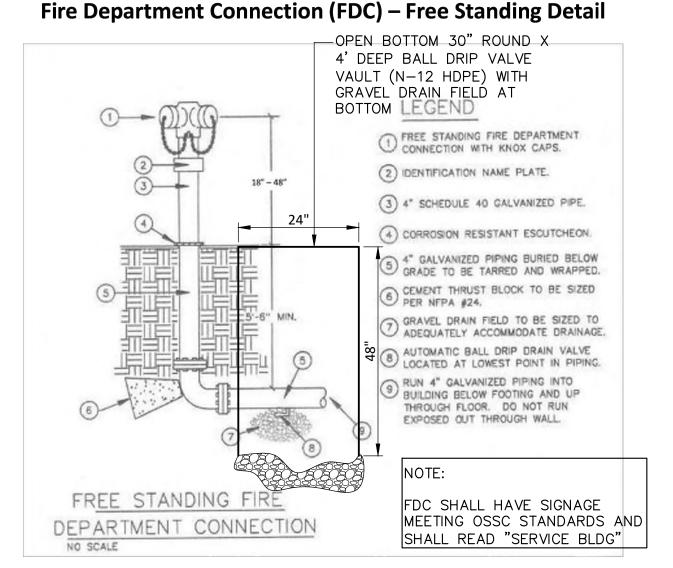

FIRE DEPARTMENT CONNECTION DETAIL SCALE: NTS



12" X 18" 0.63" WHITE RUST FREE ALUMINUM 2" WHITE LETERING ON RED BACKGROUND

FIRE DEPARTMENT SIGNAGE DETAIL SCALE: NTS



EXPIRES: 06/30/25 SIGNATURE DATE: __

© AXIS DESIGN GROUP THESE DRAWINGS ARE THE PROPERTY OF AXIS DESIGN GROUP AND ARE NOT TO BE REPRODUCED IN ANY MANNER EXCEPT WITH THE PRIOR WRITTEN APPROVAL OF AXIS DESIGN GROUP.



DESIGNGROUP 11104 S.E. STARK STREET PORTLAND, OR 97216 T: 503.284.0988 | F: 503.546.9276



MEIER EN-VOLVO E BUILDING HERZ LKSW V SERV VOL NEW

No. Description 1 2 3 4 5 6		
3 4 5		L L
5		2
5		3
		•
6		
		5
DRAWN BY: BB	BY: BB	KAWN B
CHECKED BY: KG	BY: KG	IECKED

DATE: 7/26/2024

SHEET TITLE


SHEET NO.


ISSUED FOR: LAND USE REVIEW


FIRE HYDRANT AND DCDA


DETAILS


C305

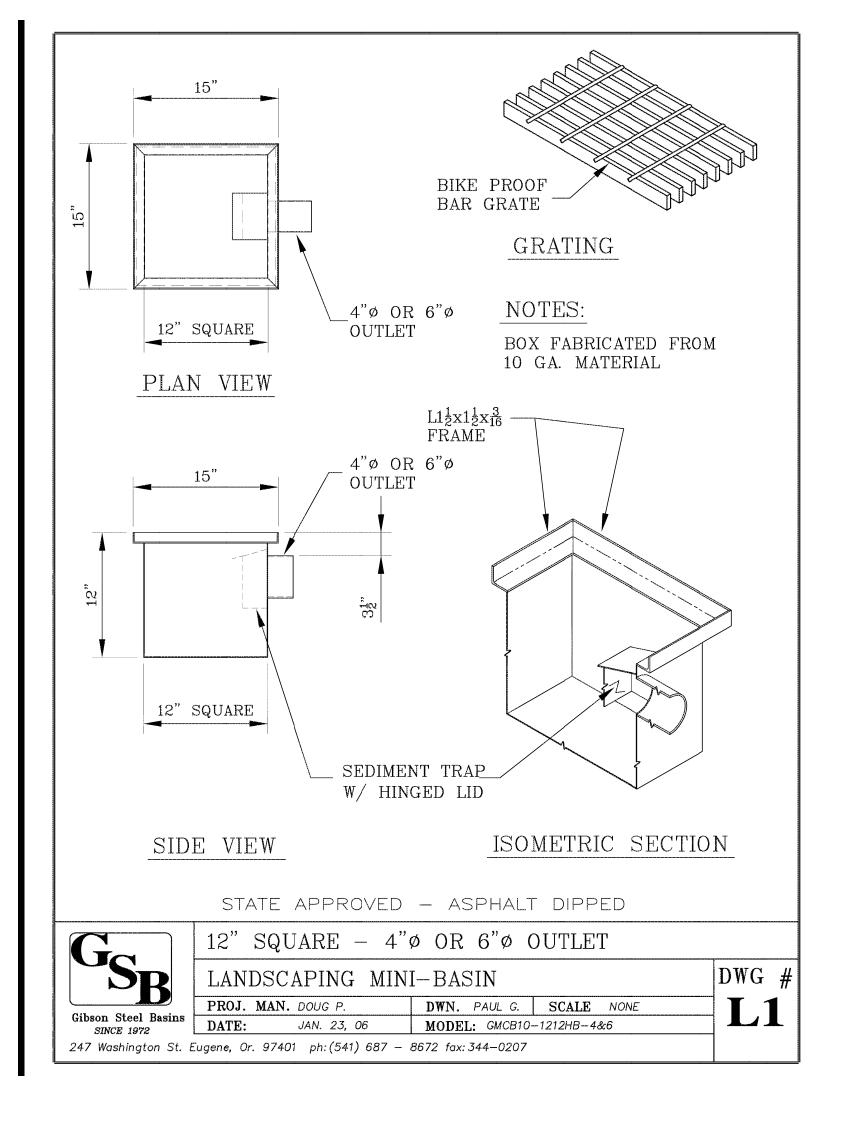

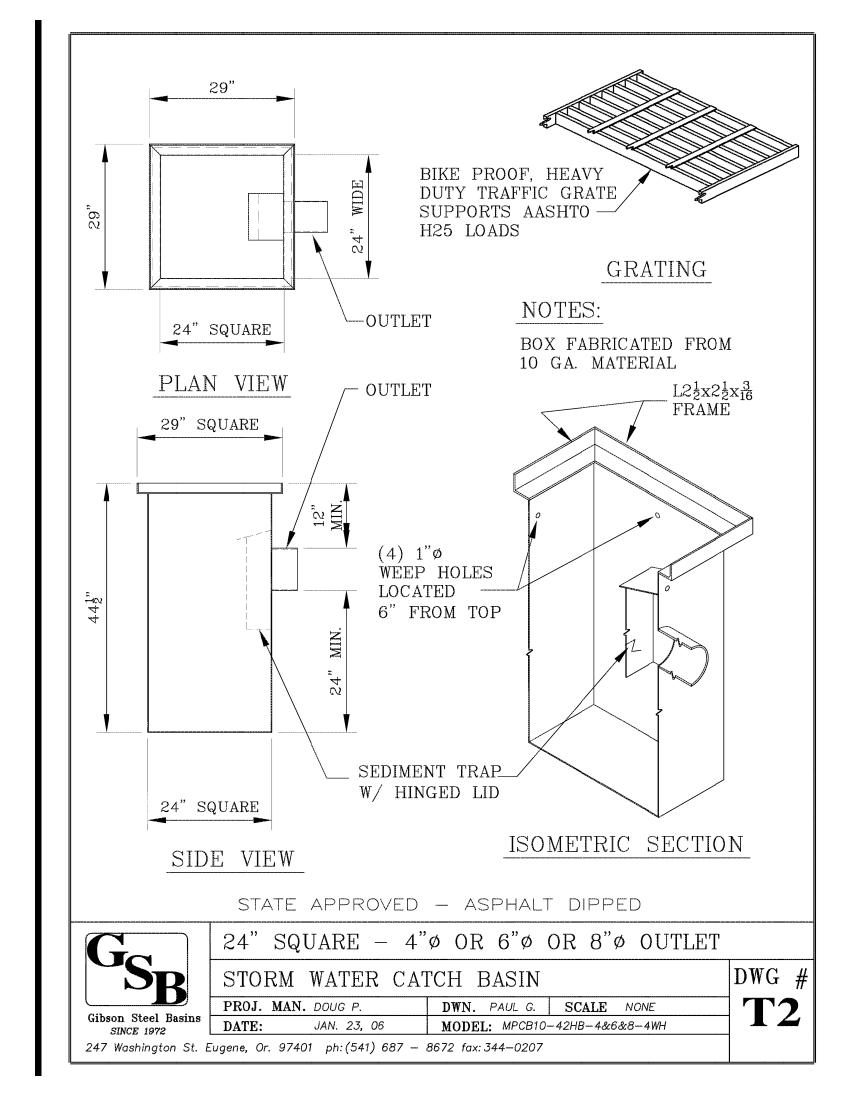

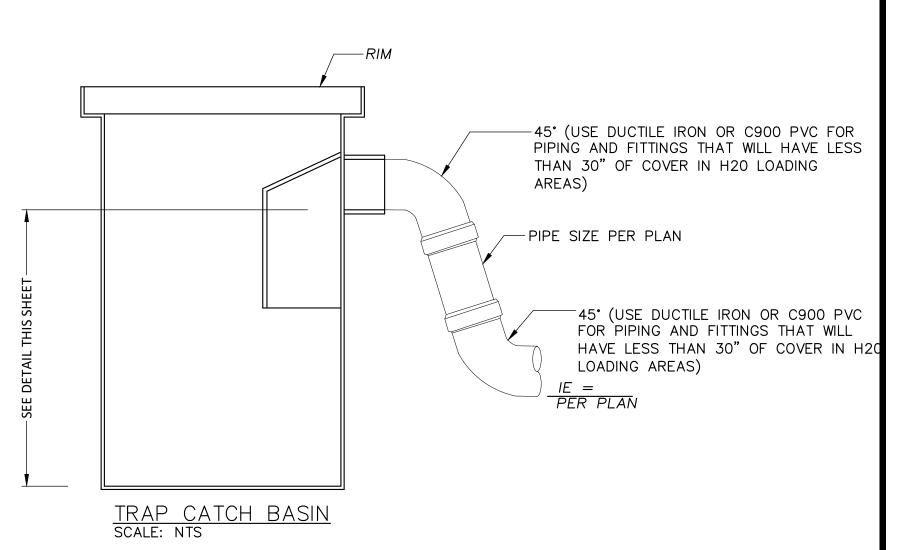

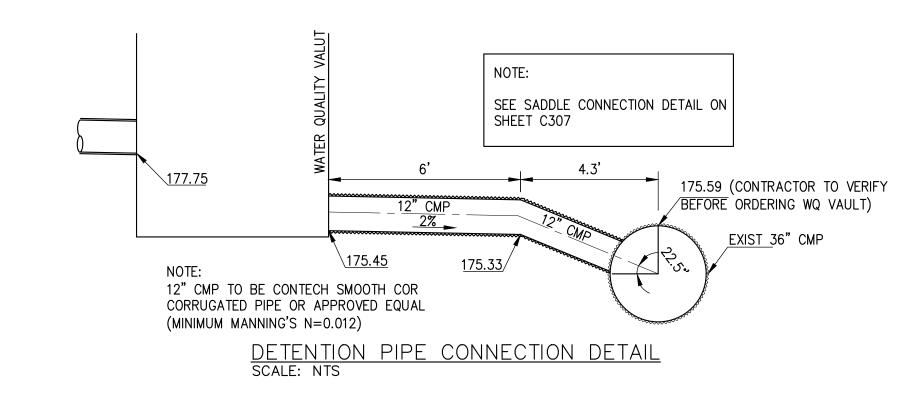

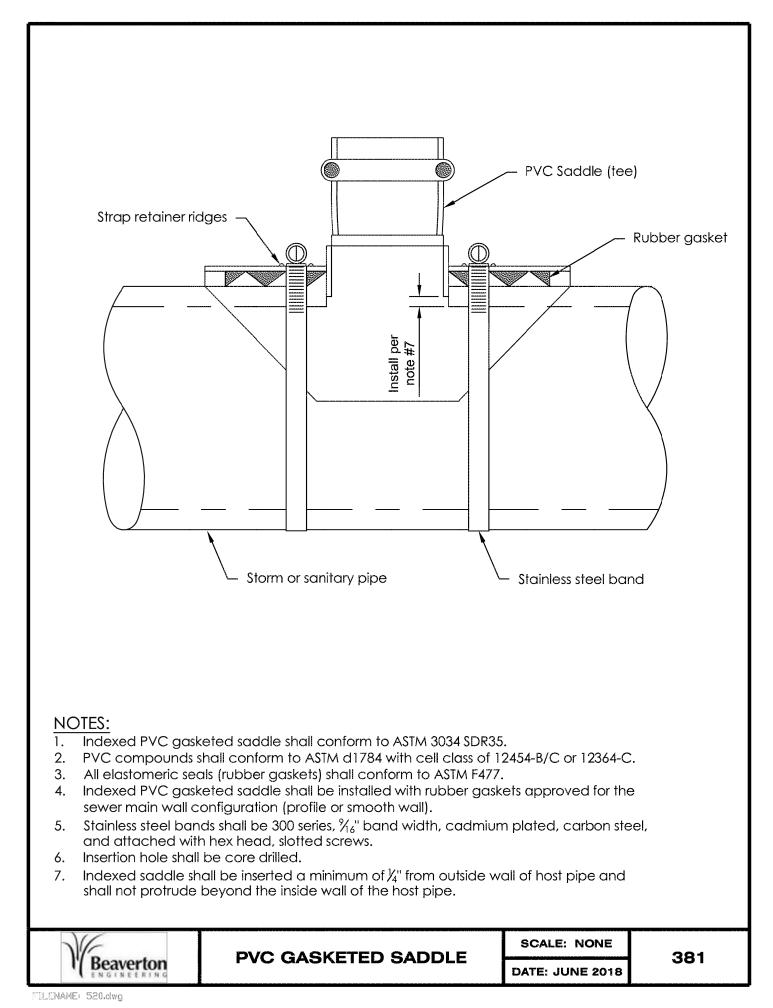



EXPIRES: 06/30/25
SIGNATURE DATE: _____

© AXIS DESIGN GROUP
THESE DRAWINGS ARE THE PROPERTY OF
AXIS DESIGN GROUP AND ARE NOT TO BE
REPRODUCED IN ANY MANNER EXCEPT WITH
THE PRIOR WRITTEN APPROVAL OF AXIS
DESIGN GROUP.



DESIGNGROUP ARCHITECTURE & ENGINEERING, INC. 11104 S.E. STARK STREET PORTLAND, OR 97216 T: 503.284.0988 | F: 503.546.9276



HERZOG MEIER VOLKSWAGEN-VOLVO VEW SERVICE BUILDING 4275 SW 139TH WAY BEAVERTON, OR 97005


No.	Description	Date
1		
2		
3		
4		
5		
6		
		+
		+
DRAW	N BY: BB	
CHECK	ED BY: KG	
JOB NO	D: E20-030	
DATF.	7/26/2024	


C306


STORM DETAILS


SHEET TITLE

SHEET NO.

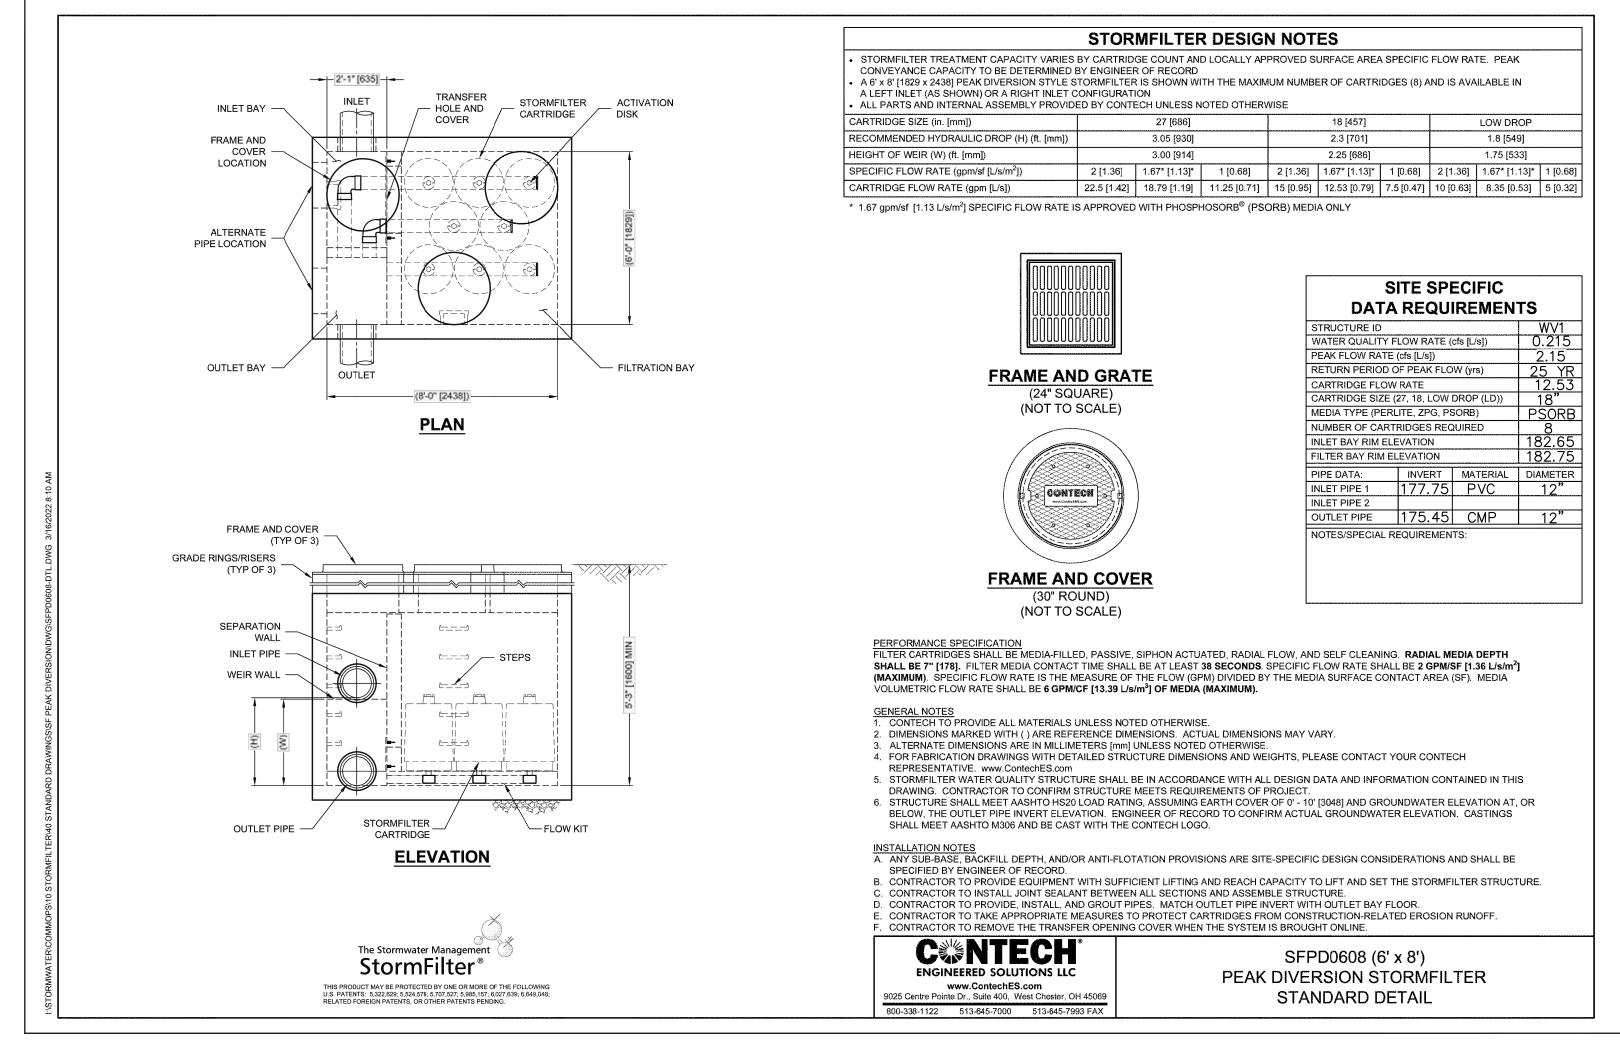

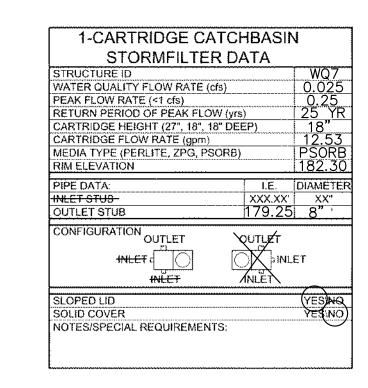

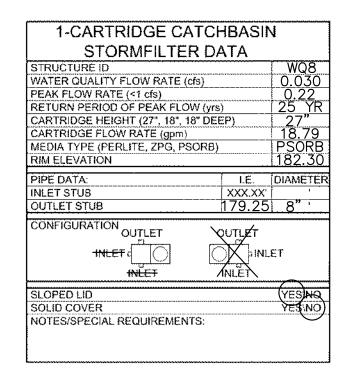

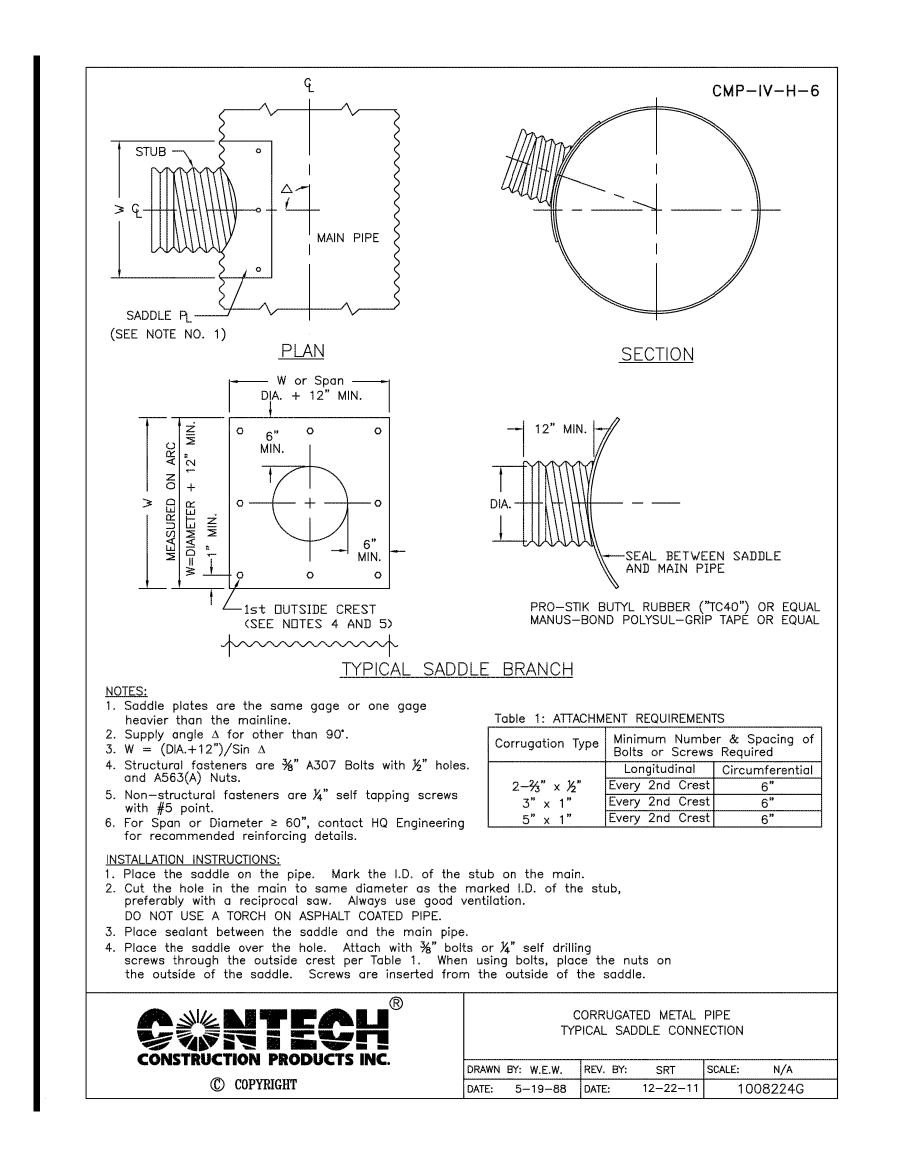



EXPIRES: 06/30/25 SIGNATURE DATE: _____

© AXIS DESIGN GROUP
THESE DRAWINGS ARE THE PROPERTY OF
AXIS DESIGN GROUP AND ARE NOT TO BE
REPRODUCED IN ANY MANNER EXCEPT WITH
THE PRIOR WRITTEN APPROVAL OF AXIS
DESIGN GROUP.



DESIGNGROUP ARCHITECTURE & ENGINEERING, INC 11104 S.E. STARK STREET PORTLAND, OR 97216 T: 503.284.0988 | F: 503.546.9276



HERZOG MEIER OLKSWAGEN-VOLVO EW SERVICE BUILDING


No.	Desc	ription	
1			
2			
3			
4			
5			
6			
DRA'	WN BY:	ВВ	
CHE	CKED BY:	KG	
JOB	NO: E20	-030	
DATI	: 7/26/2	2024	

SHEET TITLE

SHEET NO.

C307

STORM FILTER

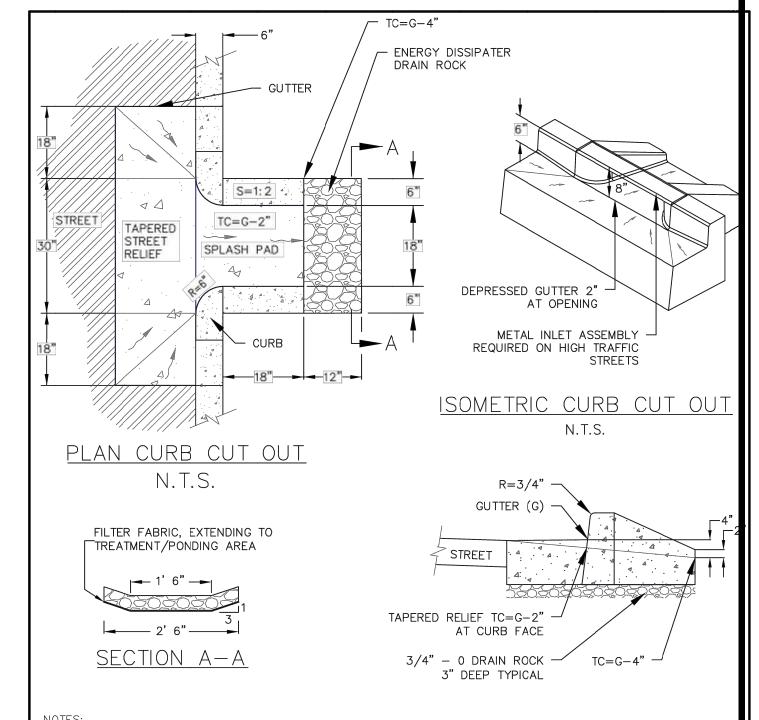

SIDEWALK DRAINAGE

MODIFIED CG-30.

- SIDEWALK DRAINAGE NOTCH

— 4" MIN. POND DEPTH

18" MIN. GROWING MEDIUM

15" DEEP (1-1/2" - 3/4")

CleanWater Services

CLEAN CRÙSHẾD DRAIN ROCK

CRUSHED DRAIN ROCK

-PERFORATED DRAIN PIPE, 8" TYP.

3" DEEP (3/4" - 1/4") CLEAN

—— 4" EXPOSED MIN.

FLÖW

SEE DETAIL 755

SEE NOTE 6

NOTCH, 4" TYP.

4-1/2" - 2-1/2"

SPLASH ROCK. 6"

STRUCTURE, TYP.

4" DIAMETER CUT

STRUCTURE TYP.

OUTS. MINIMUM 3

CUT OUTS PER INLET

NECESSARY. (SEE NOTE 3)

TREATMENT AREA

SECTION A-A

ACCORDING TO INDIVIDUAL PROJECT PLANS PER DETAIL 762. PROVIDE 2" MIN FREEBOARD.

STREET SIDE CURB NOTCHES TO BE LOCATED AS IDENTIFIED ON PROJECT PLANS.

WALL'S STRUCTURAL DESIGN AND DIMENSIONS DETERMINED BY ENGINEER.

FACILITY AREAS PRIOR TO, DURING, AND AFTER CONSTRUCTION.

TO DRAIN TO STREET OR PIPED OVERFLOW SYSTEM AS APPLICABLÉ.

SHALL ALIGN WITH SIDEWALK CONTRACTION JOINTS AND LOW POINTS.

STREET SIDE PLANTER

WITHOUT STREET PARKING

1. THIS DETAIL REPRESENTS A FLOW THROUGH PLANTER WITH FULL LENGTH CONCRETE WALLS AND FLOOR. FOR INFILTRATION PLANTER CONCRETE WALLS W/FOOTING WILL BE REQUIRED AS SHOWN ON

PROVIDE PROTECTION FROM ALL VEHICLE TRAFFIC, EQUIPMENT STAGING, AND FOOT TRAFFIC IN PROPOSED

4. SIDEWALK ELEVATION MUST BE SET ABOVE CHECK DAM AND INLET/OUTLET ELEVATIONS TO ALLOW OVERFLOW

5. PLANTER SHALL BE FLAT BOTTOM IN ALL DIRECTIONS TO WITHIN 1 INCH. CHECK DAMS SHALL BE PLACED

SIDEWALK CURB NOTCH: 1" LOWER THAN SIDEWALK, SLOPED TO FACILITY. SIDEWALK DRAINAGE NOTCHES

9. HYDRANTS, UTILITY POLES, OR ANY UTILITY BOXES PLACED WITHIN PLANTER MUST BE APPROVED BY

10. ACTUAL ELEVATIONS AND DIMENSIONS TO BE CONSTRUCTED AS IDENTIFIED ON PROJECT PLANS. . ENSURE THAT A DOWNSTREAM CATCH BASIN IS IN PLACE FOR EMERGENCY OVERFLOW.

PERFORATED PIPE IN INFILTRATION FACILITIES: BOTTOM OF PIPE SHALL BE SET AT 2 1/2" ABOVE SUBGRADE.

PERFORATED PIPE IN FLOW THROUGH FACILITIES: BOTTOM OF PIPE SHALL BE SET AT BASE OF DRAIN ROCK

MIN. AROUND

18" MIN. DIAMETER BEEHIVE STYLE

MINIMUM 4' OF 8" V

PERFORATED DRAIN PIPE * *

4" DIAMETER CUT

OUTS. MINIMUM 3 *

STRUCTURE TYP. *

CUT OUTS PER INLET

*** * * * * ***

2" MIN. FREEBOARD

TO LOWEST I.E., IN.

JURISDICTION IN WRITING.

SEE DRAWING #030

OVERFLOW PER DETAIL NO. 758/760

TRAPPED CATCH

OR APPROVED

BASIN, NYLOPLAST-

EQUAL. 12" MIN.

SEE DRAWING 760


ROADS - USE MODIFIED CG-30 SEE DETAIL 755, FOR INLET STRUCTURE. . INFLOW STRUCTURE - CURB CUT OUT SHALL HAVE MINIMUM 2" DROP AT THE FLOW LINE LEADING TO THE SPLASH PAD, SEE DETAIL. ENERGY DISSIPATER DRAIN ROCK: ROCK SIZE 4-1/2" - 2-1/2" OR SIZED BY DESIGN INFLOW. PLACE

INFLOW STRUCTURE PER LOCAL JURISDICTION. CURB CUT OUTS NOT ALLOWED ON WASHINGTON COUNTY

ROCK 6" DEEP BEHIND SPLASH PAD. 4. CURB PROFILE PER LOCAL JURISDICTION. . ENSURE THAT DOWNSTREAM CATCH BASINS ARE IN PLACE FOR HIGH FLOW CONVEYANCE.

> CleanWater Services REVISED 10-31-19



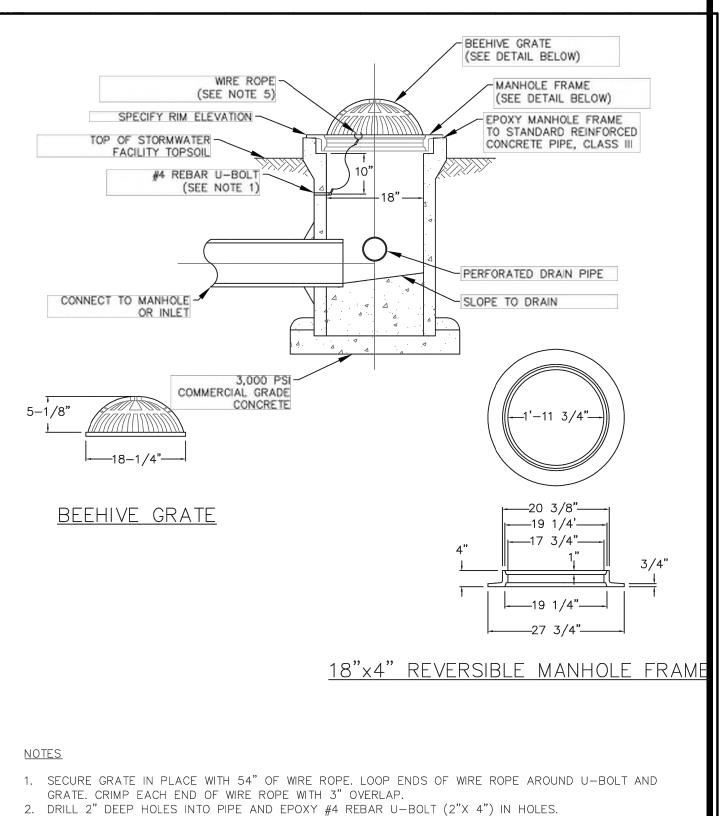

3. GRATE TO BE CAST IRON, ASTM A48 CL30.


DRAWING NO. 758


4. SIZE INLET BASED ON CALCULATED FLOWS AND MANUFACTURERS RECOMMENDATIONS. 5. WIRE ROPE BETWEEN 1/8"-3/16" DIAMETER, STAINLESS STEEL, 7 STRANDS OF 19 WIRES.

REVISED 10-31-1

CleanWater Services

BEEHIVE INLET

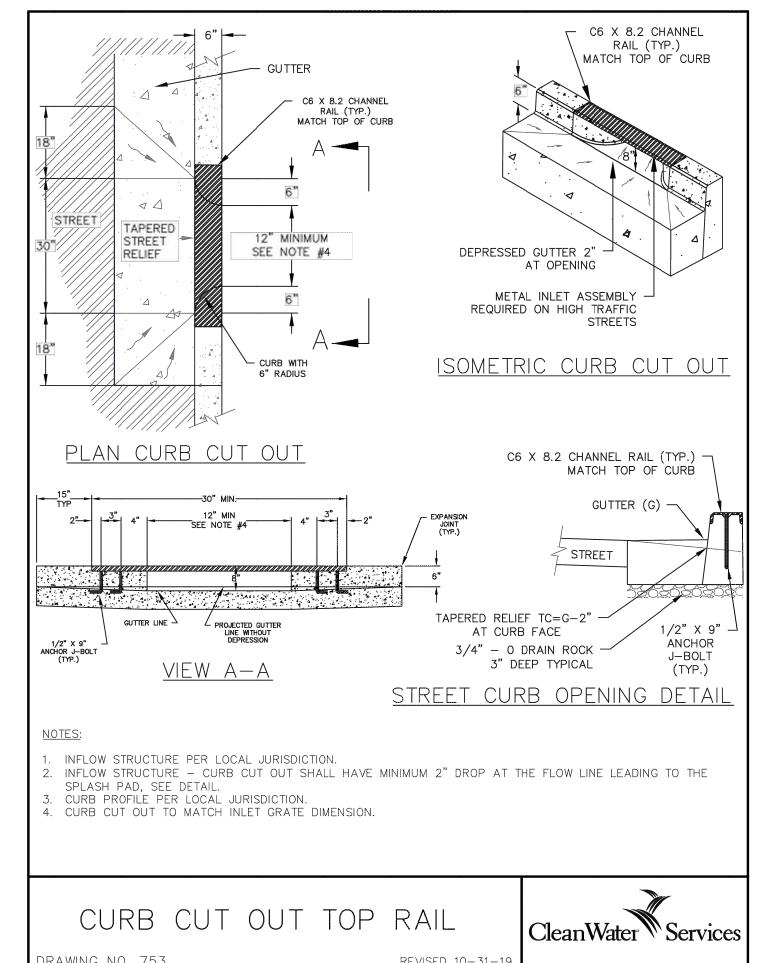

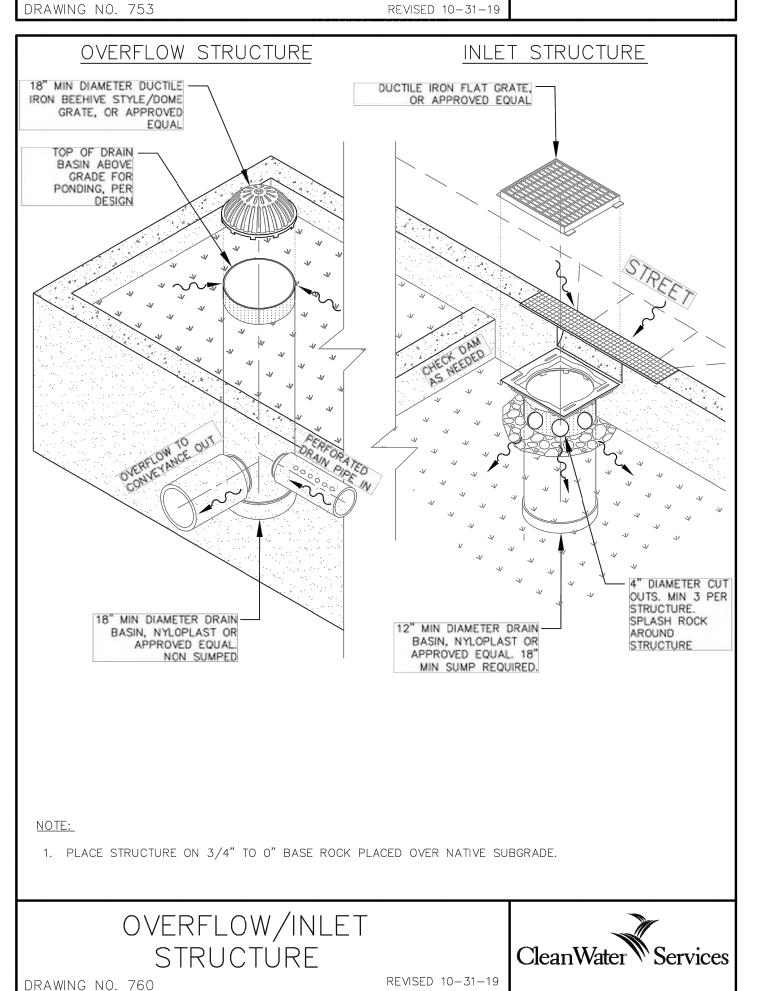



EXPIRES: 06/30/25 SIGNATURE DATE: ___

© AXIS DESIGN GROUP THESE DRAWINGS ARE THE PROPERTY OF



AXIS DESIGN GROUP AND ARE NOT TO BE REPRODUCED IN ANY MANNER EXCEPT WITH

THE PRIOR WRITTEN APPROVAL OF AXIS


DESIGNGROUP 11104 S.E. STARK STREET PORTLAND, OR 97216 T: 503.284.0988 | F: 503.546.9276





No.	Descr	iption	D
1			
2			
3			
4			
5			
6			
DRA	NN BY:	ВВ	
CHE	CKED BY:	KG	
JOB	NO: E20-	030	
DATI	: 7/26/2	024	
_,			


SHEET NO.

C308

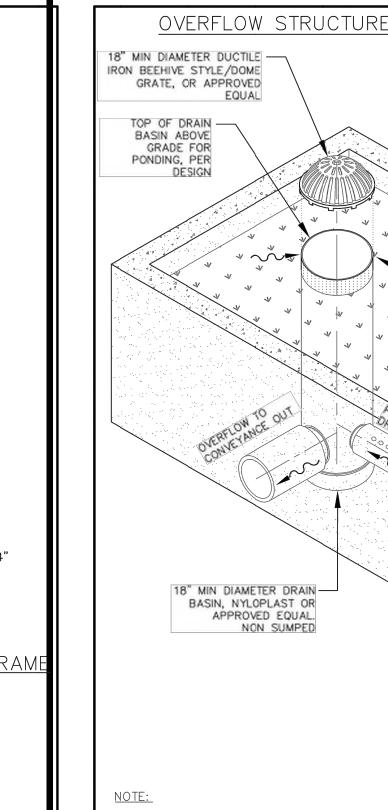

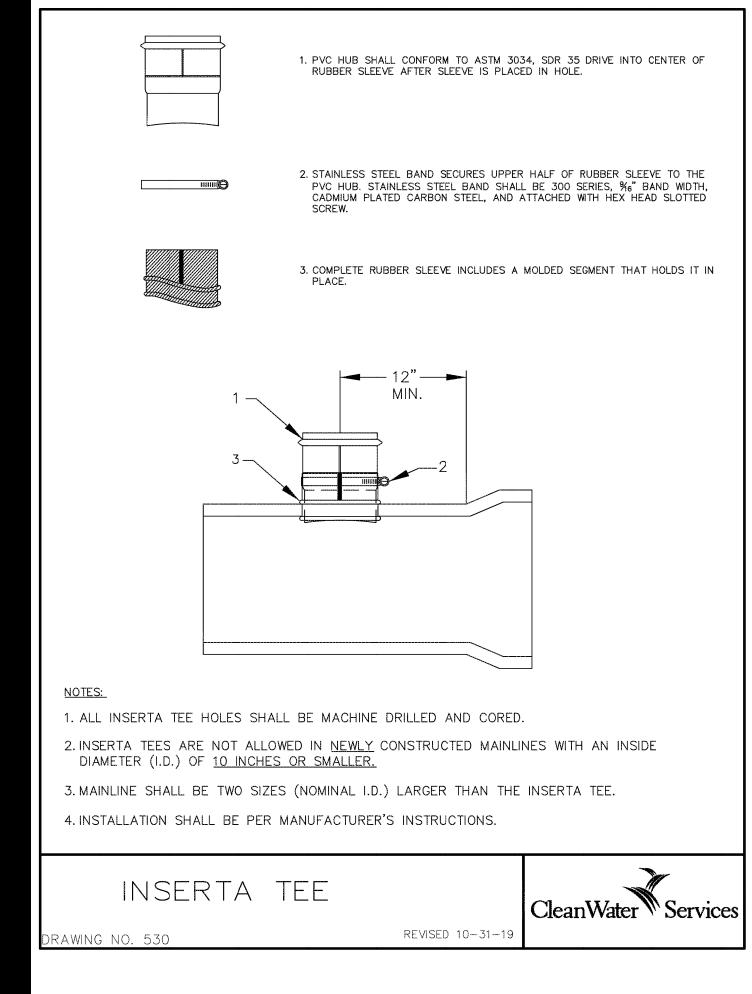

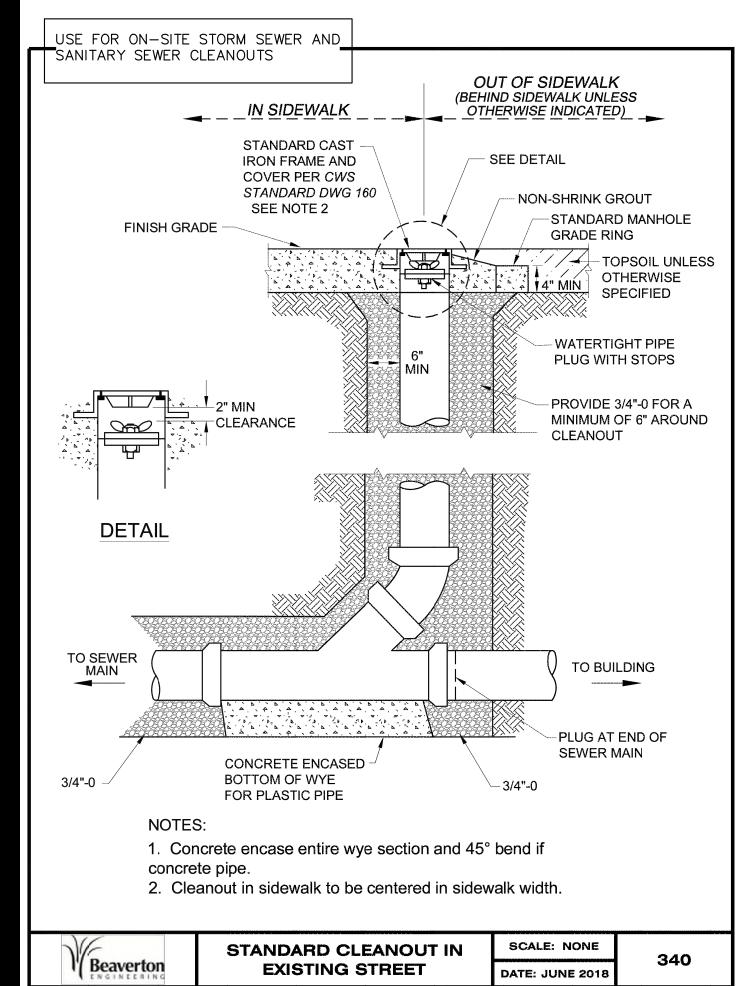

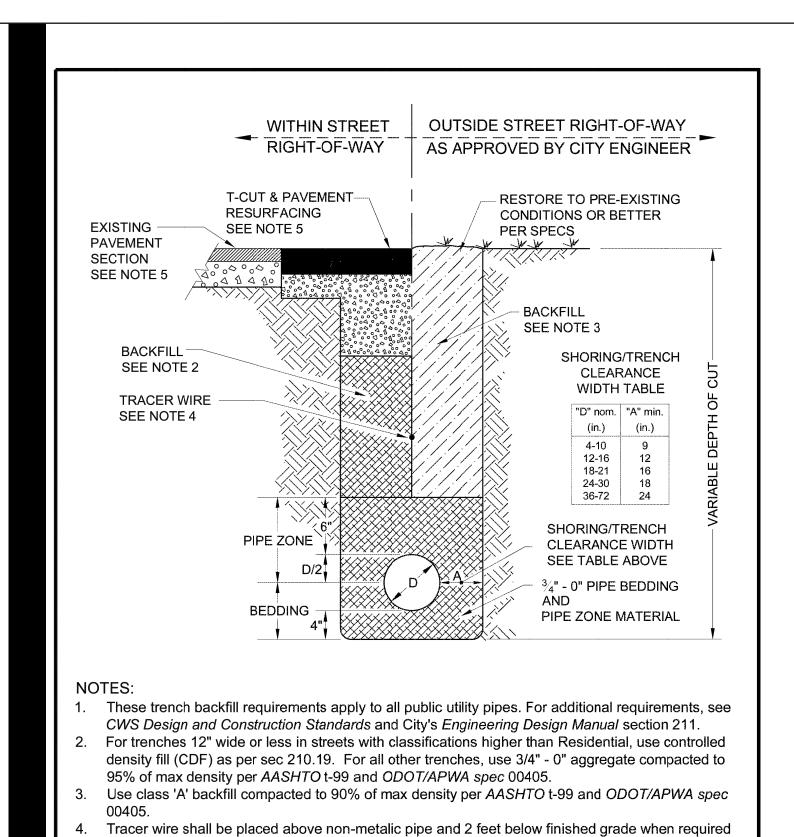

Restore to original conditions or better. See specifications and drawing 302. 6. For conduit trench requirements see drawing 301. The City reserves the right to require compaction testing of the bedding material when it exceeds the 4-inch base section beneath the pipe. SCALE: NONE 300

by Oregon State Plumbing code. Reference City's EDM section 211.1.4.o. Storm and sanitary

sewer services shall be marked with magnetic tape per CWS D&C section 5.09.4.c

Beaverton FILENAME: 300.dwg

PIPE TRENCH BACKFILL DATE: JUNE 2018


3/4" SQUARE— (a) a S - a (a | - 9 7/8" ----SECTION B-B SECTION A-A 1. ¼" ALLEN HEAD BOLTS 1" LONG RECESSED. 2. ALL PERMANENT CLEANOUTS TO HAVE BOLT DOWN COVERS. 3. MATERIAL SHALL BE GRAY CAST-IRON, ASTM A-48, CLASS 30. DETAIL CLEANOUT FRAME


REVISED 10-31-19

CleanWater \ Services

AND COVER

DRAWING NO. 510

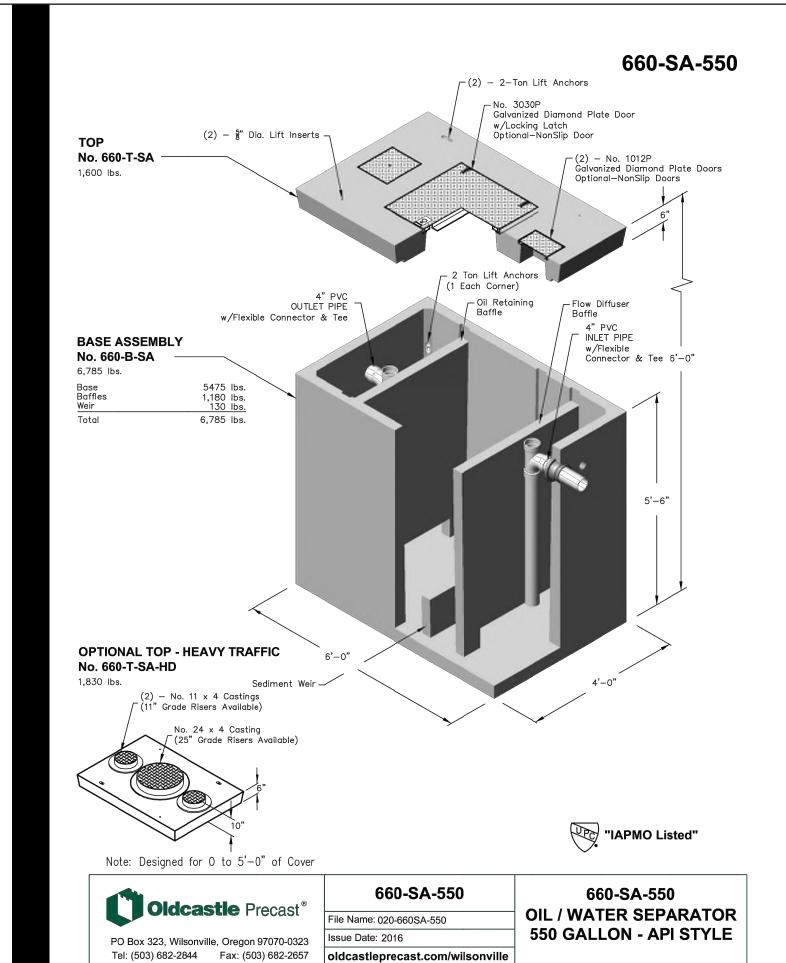

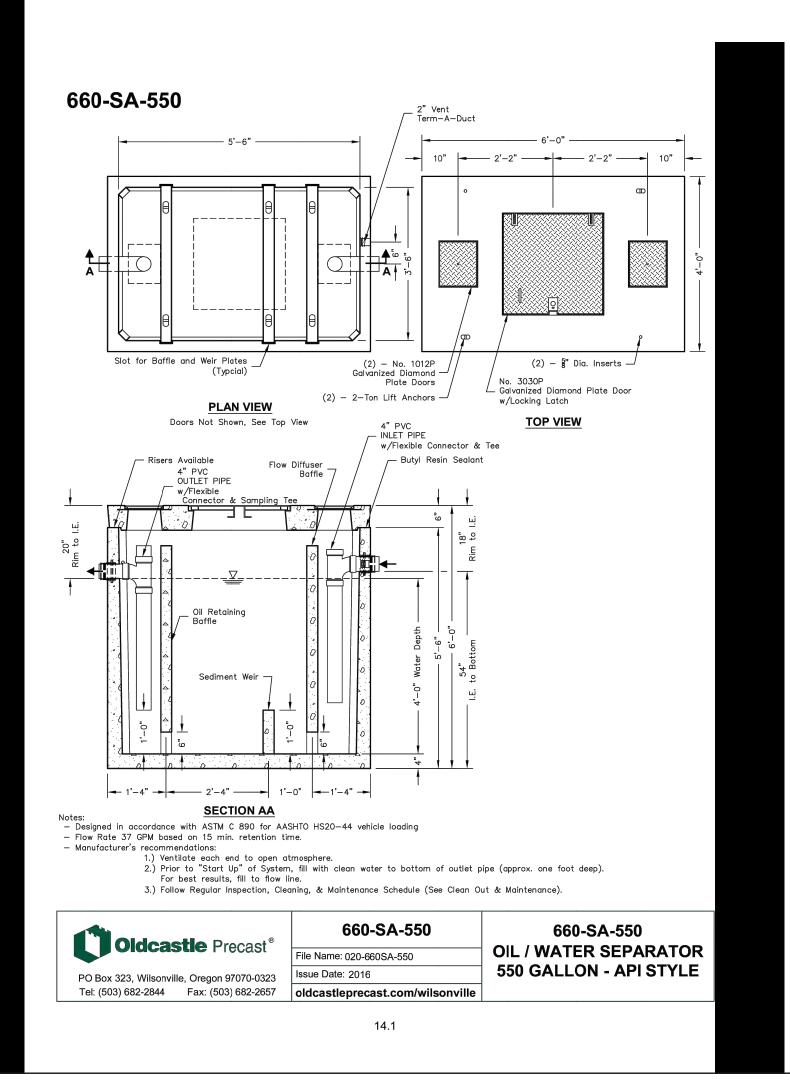



EXPIRES: 06/30/25 SIGNATURE DATE: ___

© AXIS DESIGN GROUP THESE DRAWINGS ARE THE PROPERTY OF AXIS DESIGN GROUP AND ARE NOT TO BE REPRODUCED IN ANY MANNER EXCEPT WITH THE PRIOR WRITTEN APPROVAL OF AXIS



DESIGNGROUP 11104 S.E. STARK STREET PORTLAND, OR 97216 T: 503.284.0988 | F:


503.546.9276


FIRWOOD Reliable Engineering Solutions 359 E. HISTORIC COLUMBIA RIVER HWY TROUTDALE, OREGON 97060


(503) 668-3737

MEIER EN-VOLVO E BUILDING

REVI	SIONS	
No.	Description	Date
1	•	
2		
3		
5		
6		
DRA	WN BY: BB	
CHE	CKED BY: KG	
JOB	NO: E20-030	
DATE	7/26/2024	
ISSU	ED FOR: LAND USE RE	EVIEW
SHEE	T TITLE	
	SEWER DETAILS	: 1
	SEWER DETAILS	, ,
SHEE	T NO.	
	C309)
	$\cup \cup \cup \subseteq$)

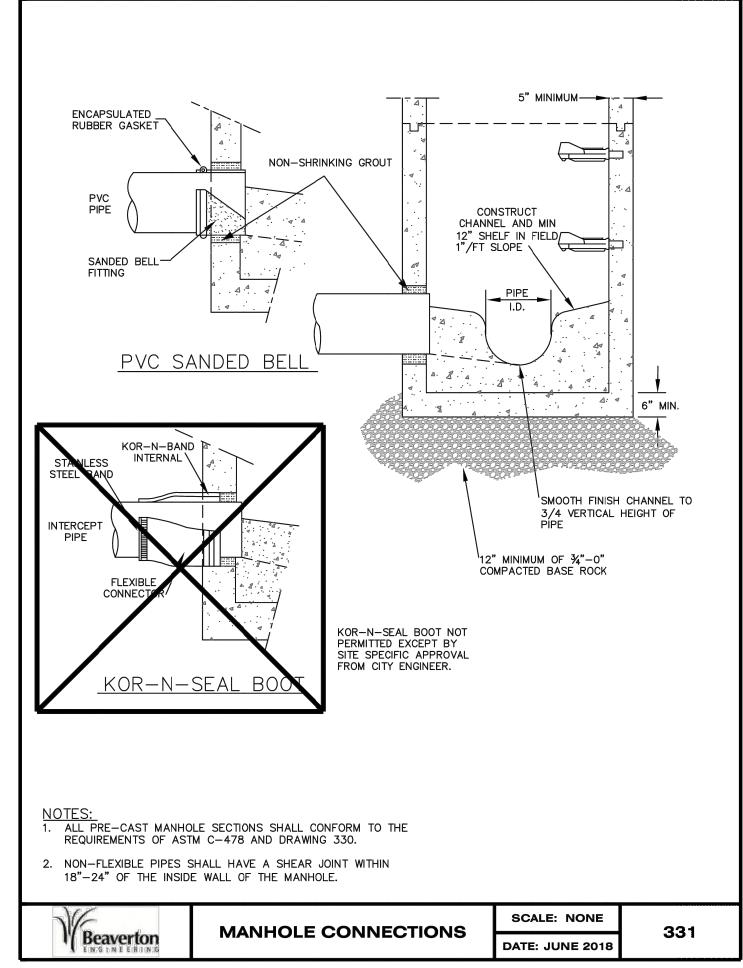


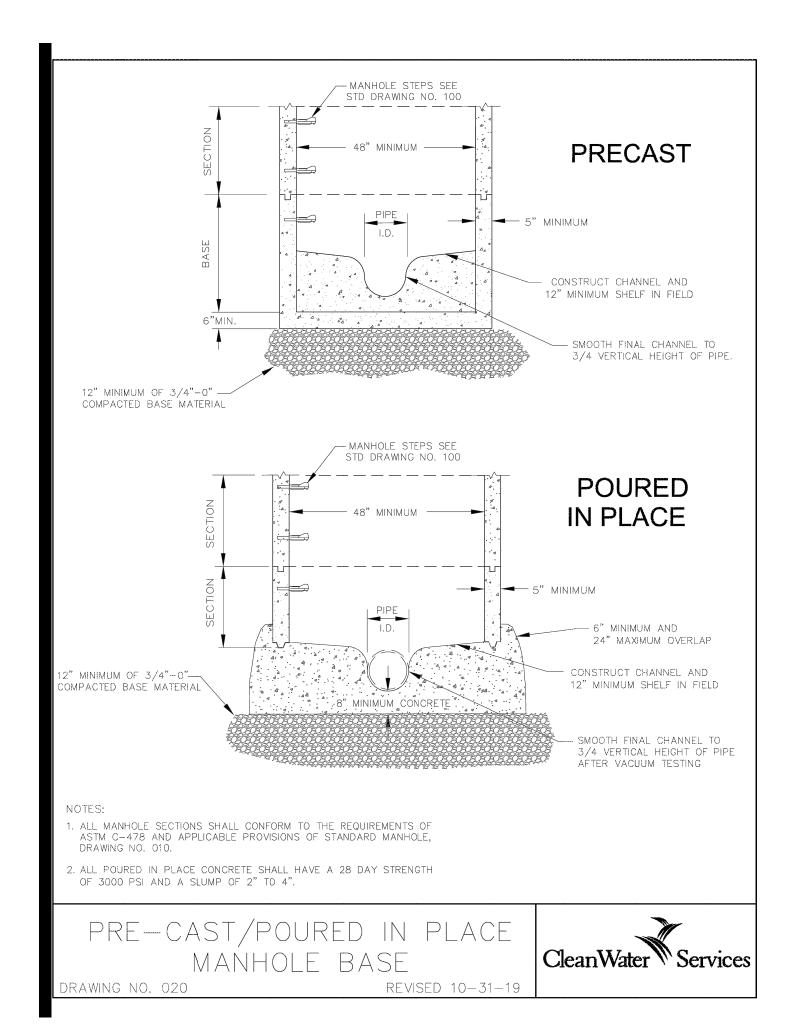

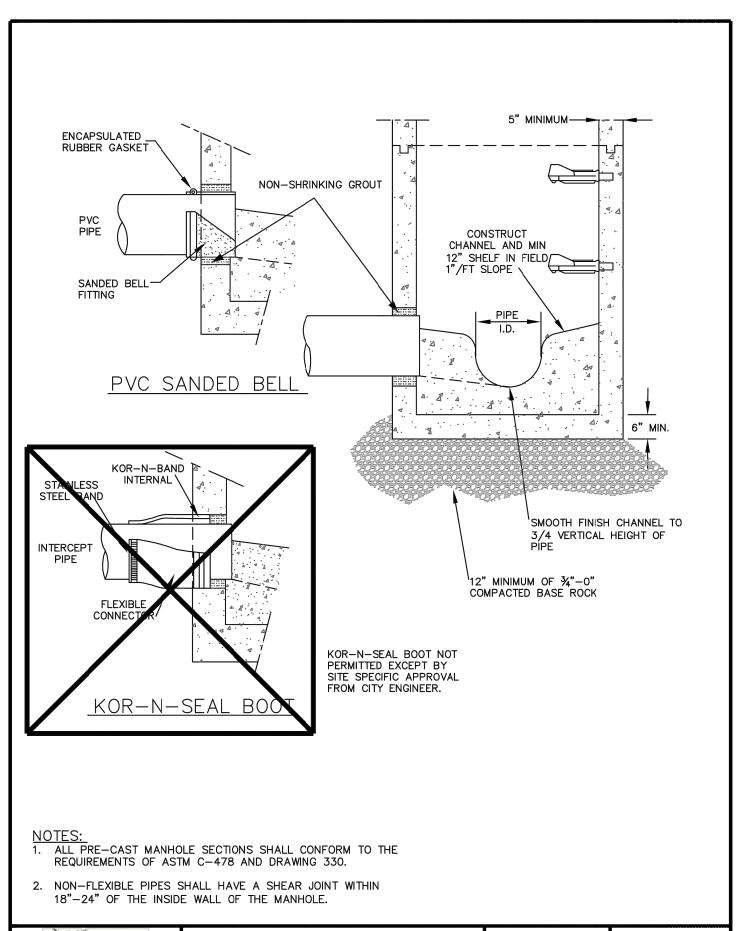



SPECIFICATION SHEET

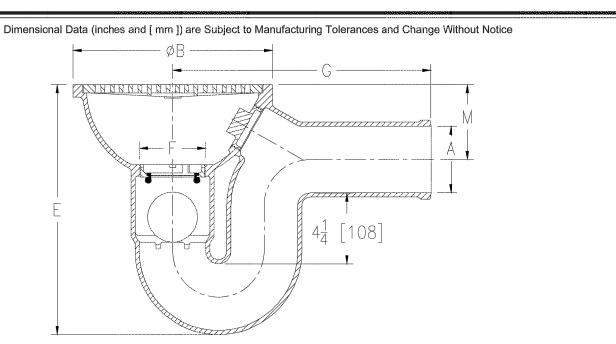

	Dime	nsions In Incl	nes [mm]	[mm]		Grate Open
A Pipe Size	F N.P.T.	В	G	М	Wt. Lbs. [kg]	Area Sq. In. [cm²]
2 [51]	2 [51]	8-1/4 [210]	10-1/8 [257]	3-1/2 [89]	17 [7]	13 [84]
3 [76]	3-1/2 [89]	10-1/2 [267]	12-1/2 [318]	4 [102]	36 [16]	19 [123]
4 [102]	3-1/2 [89]	12 [305]	15-1/2 [394]	4-1/2 [114]	54 [24]	40 [258]

ENGINEERING SPECIFICATION ZURN Z742

8", 10" or 12" [203mm, 254mm or 305mm] Diameter top drain, Dura-Coated cast iron body with integral double wall trap and side outlet, with ball float type backwater valve, internal bronze cleanout and light-duty loose slotted grate.

OPTIONS (Check/specify appropriate options)

PIPE SIZE 2 [51] 3 [76] 4 [102]	(Specify size/type) OUTLET SP Spigot SP Spigot SP Spigot	'E' BODY HT. DIM. 10-3/4 [273] 12-3/4 [324] 15 [381]
PREFIXES Z ZB ZN	D.C.C.I. Body and Top* D.C.C.I. Body with Polished Bronze Top (Add 3/16 [5] to 'E' Dim.) D.C.C.I. Body with Polished Nickel Bronze Top (Add 3/16 [5] to 'E' Dim.)	
SUFFIXES GLVTS	Galvanized Cast Iron (Less) Backwater Valve Top Secured with Slotted Screws	

____ -VP Vandal-Proof Secured Top

* Regularly furnished unless otherwise specified. Zurn Industries, LLC | Specification Drainage Operation 1801 Pittsburgh Avenue, Erie, PA U.S.A. 16502 Ph. 855-663-9876, Fax 814-454-7929 In Canada | Zurn Industries Limited 3544 Nashua Drive, Mississauga, Ontario L4V 1L2 · Ph. 905-405-8272, Fax 905-405-1292

Date: 09/27/17 C.N. No. 137945 Prod. | Dwg. No. Z742



EXPIRES: 06/30/25 SIGNATURE DATE: ___

© AXIS DESIGN GROUP THESE DRAWINGS ARE THE PROPERTY OF AXIS DESIGN GROUP AND ARE NOT TO BE REPRODUCED IN ANY MANNER EXCEPT WITH THE PRIOR WRITTEN APPROVAL OF AXIS



DESIGNGROUP 11104 S.E. STARK STREET PORTLAND, OR 97216 T: 503.284.0988 | F:


503.546.9276




MEIER EN-VOLVO E BUILDING A A Sw

No.	Descr	iption	Da
1			
2			
3			
4			
5			
6			
DRA	NN BY:	ВВ	
CHEC	CKED BY:	KG	
JOB	NO: E20-	030	
DATE	: 7/26/2	024	
	ED FOR: LA		

SHEET NO.

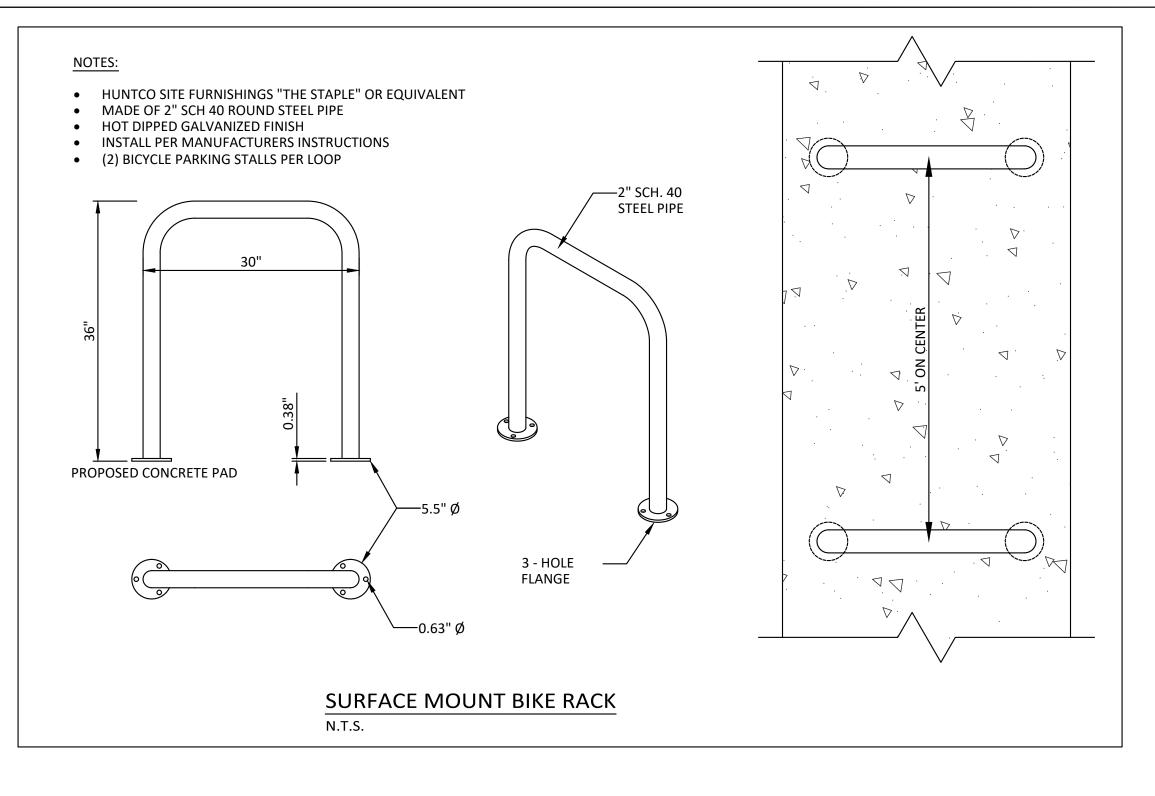

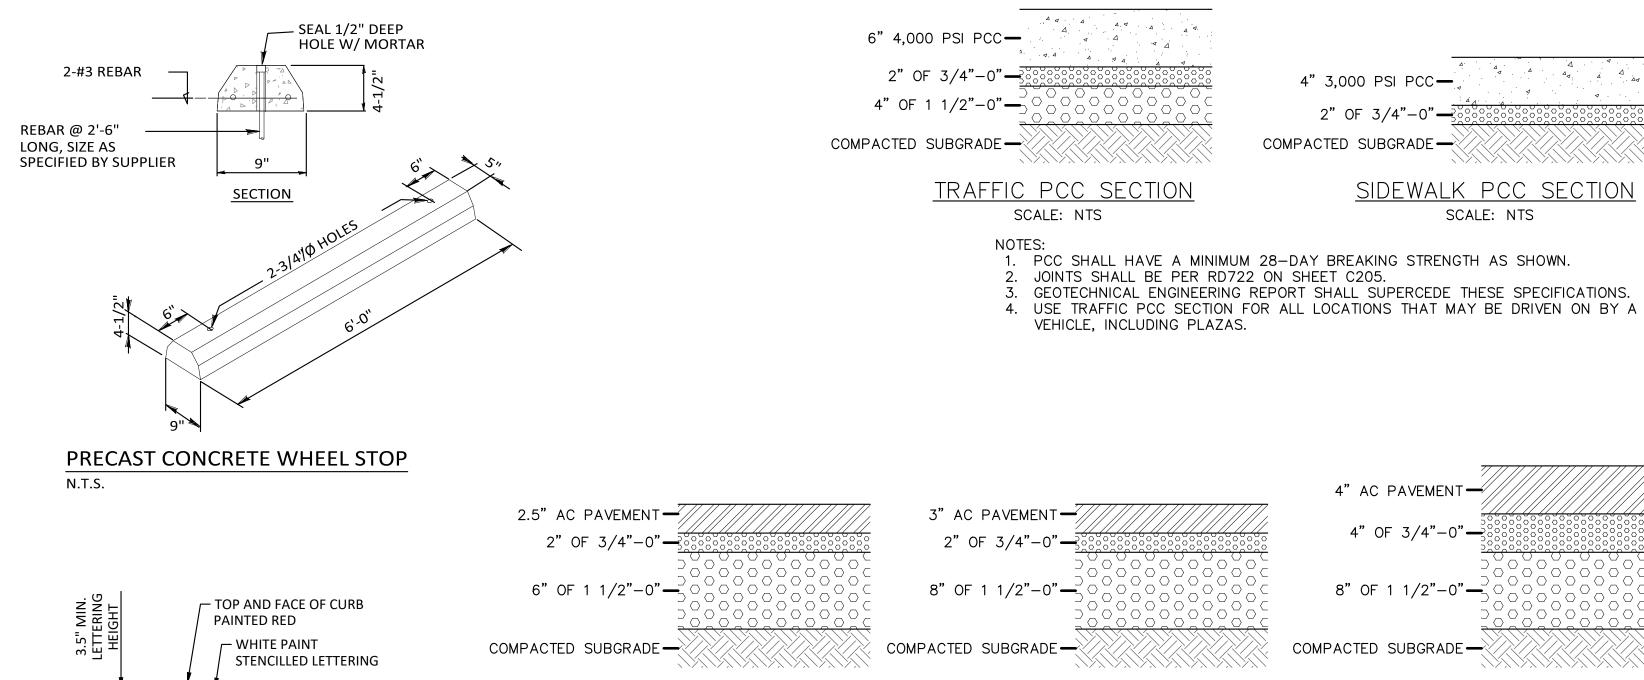

LIGHT ACP SECTION, PARKING

SCALE: NTS (FOR AUTOMOBILE-ONLY PARKING)

NO PARKING - FIRE LANE


PAVEMENT


1. LETTERING SHALL HAVE A STROKE OF 3 1/2" HEIGHT AND 1" WIDE,


NO PARKING — FIRE LANE MARKING


NOT TO SCALE

2. LETTERING SHALL BE SPACED AT 25 FEET ON CENTER.

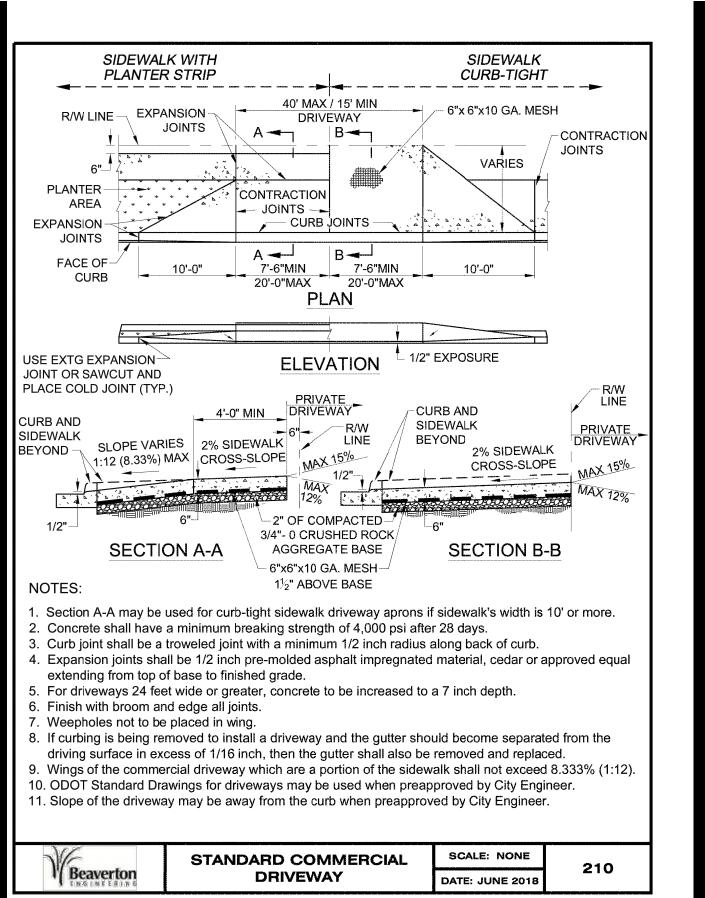

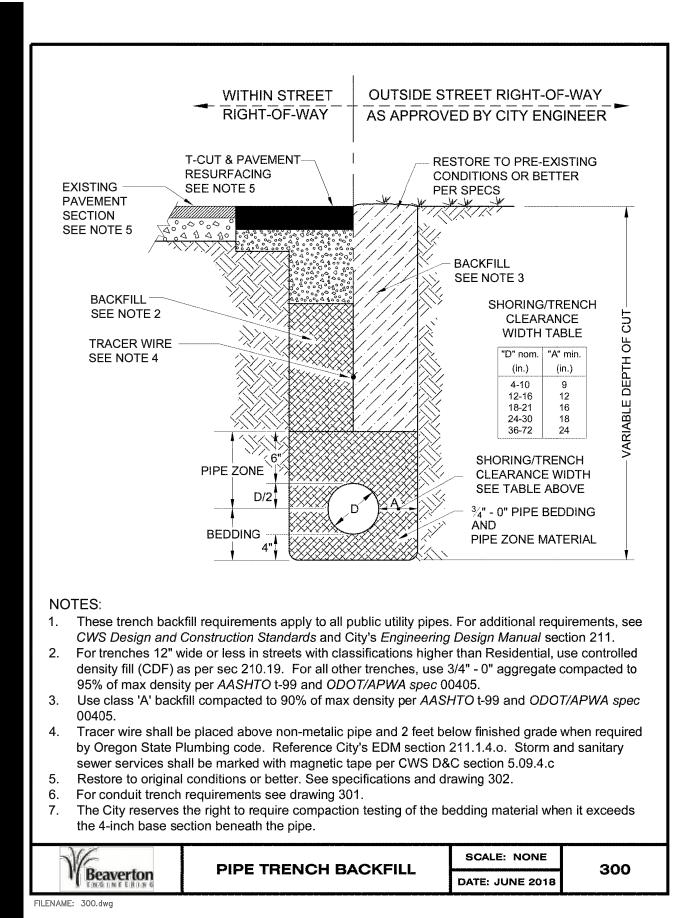

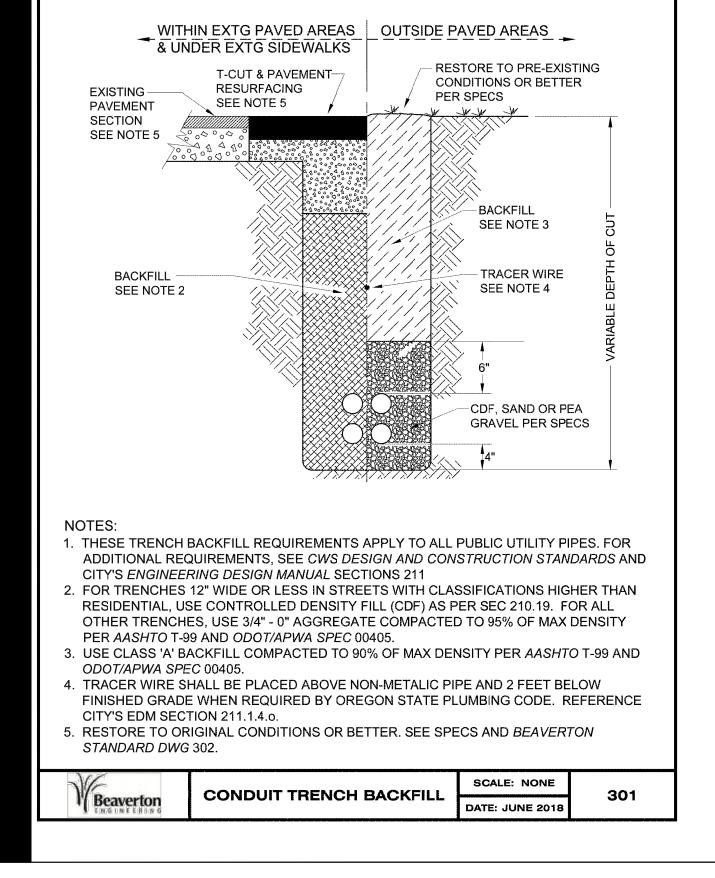

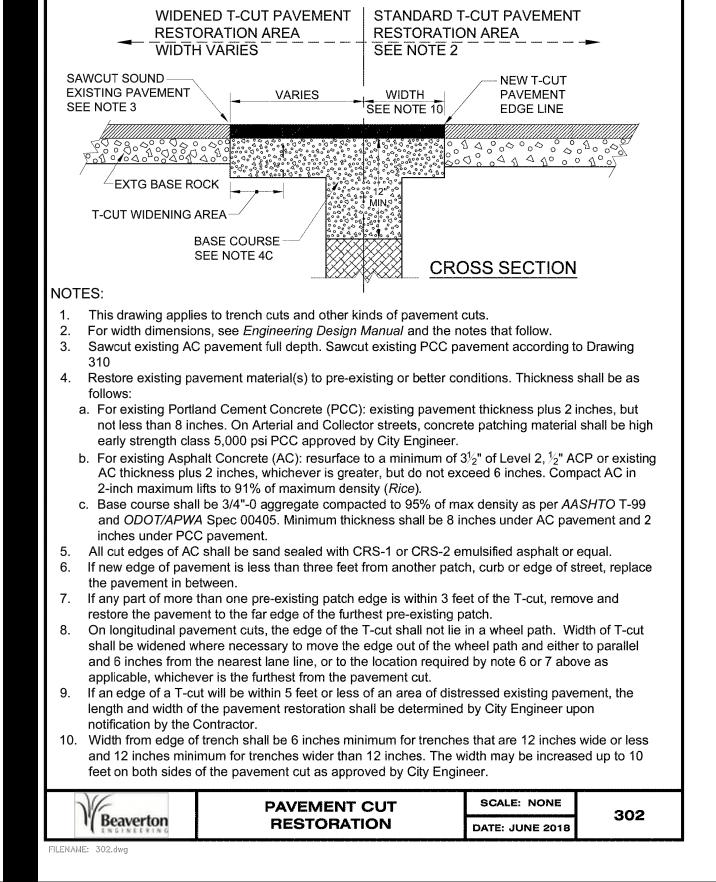

1. AC SHALL BE LEVEL 2, 1/2" DENSE MIX ACP CONFORMING TO OSSC

AGGREGATE BASE ROCK SHALL BE COMPACTED TO 95% MIN AS

5. GEOTECHNICAL ENGINEERING REPORT SHALL SUPERCEDE THESE

00744 AND COMPACTED TO 91% MAXIMUM SPECIFIC GRAVITY AS

LIGHT ACP SECTION

SCALE: NTS (AUTOMOBILE-ONLY AISLES)

SPECIFICATIONS.

DETERMINED BY AASHTO T-209

ASPHALT BINDER SHALL BE PG 64-22

DETERMINED BY MODIFIED PROCTOR (ASTM D1557)

MINIMUM LIFT THICKNESS IS 2"

NOTES:



EXPIRES: 06/30/25 SIGNATURE DATE: _____

© AXIS DESIGN GROUP
THESE DRAWINGS ARE THE PROPERTY OF
AXIS DESIGN GROUP AND ARE NOT TO BE
REPRODUCED IN ANY MANNER EXCEPT WITH
THE PRIOR WRITTEN APPROVAL OF AXIS
DESIGN GROUP.



DESIGNGROUP ARCHITECTURE & ENGINEERING, INC. 11104 S.E. STARK STREET PORTLAND, OR 97216 T: 503.284.0988 | F: 503.546.9276



(503) 668-3737

HEAVY ACP SECTION

SCALE: NTS (TRUCK AREAS)

HERZOG MEIER
VOLKSWAGEN-VOLVO
EW SERVICE BUILDING
4275 SW 139TH WAY

No.	Description	Date
1	•	
2		
3		
4		
5		
6		
	N BY: BB	
JNAVV	IN DT. DD	
CHECK	ED BY: KG	
JOB NO	O: E20-030	
DATE:	7/26/2024	
	FOR: LAND USE	REVIEW
		REVIEW

SHEET NO.

C311

b. Cold joint. c. Side of inlet structures.

d. Side of driveways. 4. Expansion joint material to be pre-molded, asphalt impregnated, non-extruding, with a

thickness of 1/2 inch. 5. Contraction Joints shall have:

a. Spacing of not more than 15 feet.

b. Depth of joint of at least $1\frac{1}{2}$ inches.

6. Base rock $1\frac{1}{2}$ "-0 or $3\frac{4}{0}$, 95% (AASHTO T-180) compaction. Base rock shall be to subgrade of street structure or 7.5 inches, whichever is greater, and shall extend 12 inches behind the curb.

a. 3-inch diameter I.D. plastic pipe with coupling and beveled outlet end to match face of curb.


7. Drainage weephole shall be:

b. Centered with contraction joints.

c. Core-drilled through existing curbs for drainage access.

8. Proof roll subgrade and base rock section prior to placement of curb.

SCALE: NONE STANDARD MONOLITHIC Beaverton **CURB AND GUTTER**

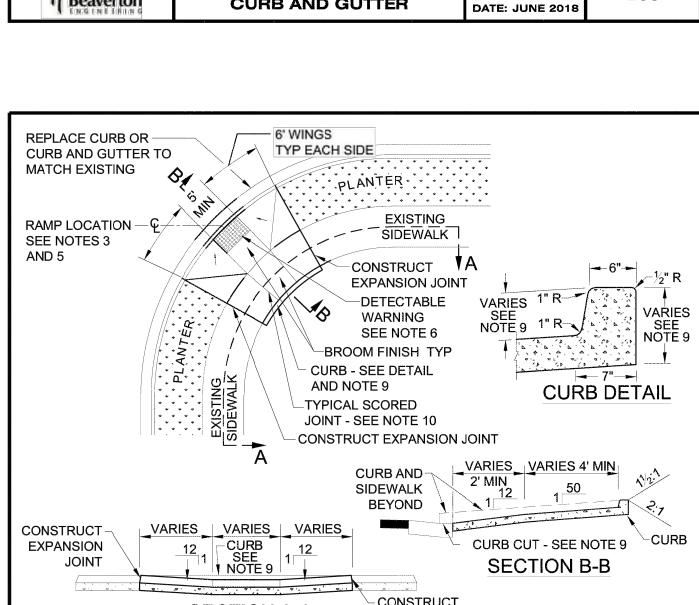

1. Retrofit ramp REQUIRES PREAPPROVAL by the City Engineer.

2. Sidewalk ramp shall meet ADA Standards.

3. This drawing is for retrofitted ramps only, where site constraints prohibit installing two ramps. The Engineer shall prepare a site-specific drawing for each ramp, accepting full responsibility for correcting

EXPANSION JOINT

all unacceptable ramp construction resulting from applying this drawing "as is". Sawcut and remove the existing sidewalk, curb and gutter to the nearest cold joint.

5. Ramp shall be located relative to crosswalk or stop line.

6. Detectable warning shall be 24 inches long in the direction of travel and full width of the ramp, made of concrete imbedded yellow tiles, that have truncated domes aligned on a square grid with its gridlines parallel and perpendicular to the centerline of the ramp, from the approved list in the Engineering Design Manual, Sec 210.10.

Concrete shall have a compressive strength of 4,000 psi at 28 days.

8. Bevel the curb cut from gutter to back of curb at 8.33% (1:12).

9. Construct curb with varying exposure tapered longitudinally so that the top of the curb matches the normal projected back of sidewalk as shown in section B-B.

10. Score at grade changes, surface texture changes and at other points shown. Edges shall be shined.


RETROFIT SINGLE SIDEWALK


RAMP WITH PLANTER STRIP

11. Curb inlet or catch basin shall not be allowed in front of sidewalk ramp.

Beaverton

231

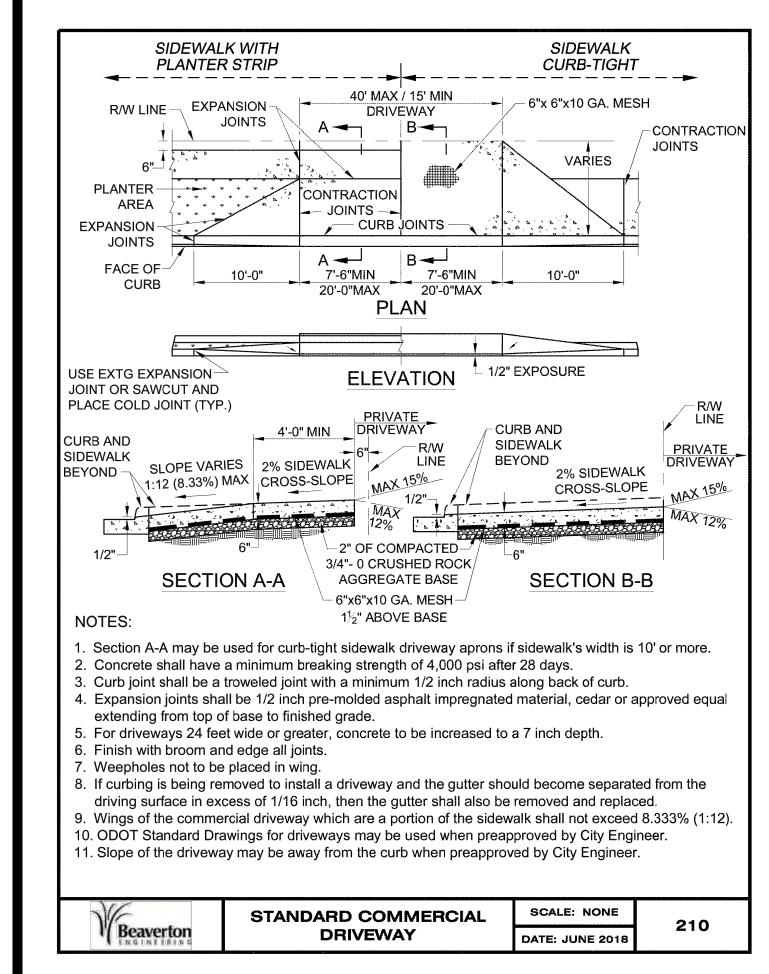

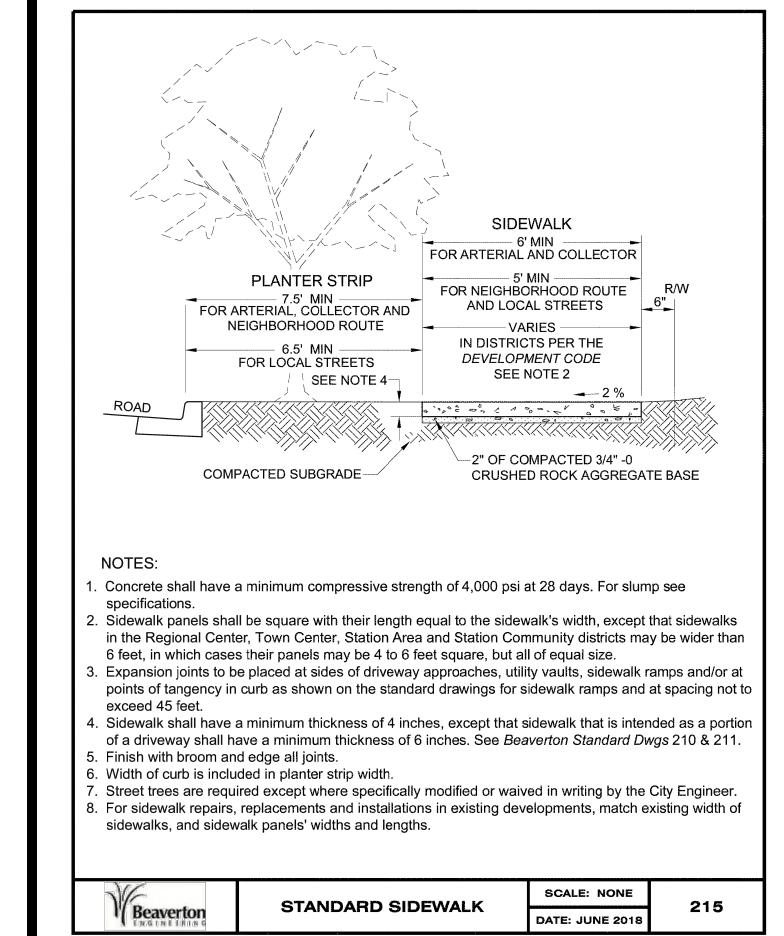



EXPIRES: 06/30/25 SIGNATURE DATE: ___

© AXIS DESIGN GROUP THESE DRAWINGS ARE THE PROPERTY OF AXIS DESIGN GROUP AND ARE NOT TO BE REPRODUCED IN ANY MANNER EXCEPT WITH THE PRIOR WRITTEN APPROVAL OF AXIS



DESIGNGROUP 11104 S.E. STARK STREET PORTLAND, OR 97216 T: 503.284.0988 | F: 503.546.9276



No.	Descri	iption	
1			
2			
3			
4			
5			
6			
DD AVA(A) D			
DRAWN B	SY:	ВВ	
CHECKED	BY:	KG	
JOB NO:	E20-	030	

SHEET NO.

SHEET TITLE

C312

ISSUED FOR: LAND USE REVIEW

SITE DETAILS 2

OREGON TRANSPORTATION COMMISSION Standards for Accessible Parking Places August 2018

Figure 2

9' Min - 9' Min 9' Min

Pavement markings required. See Figures 6 & 7 for details

* Detectable warning surface required if curb ramp is located within public right-of-way

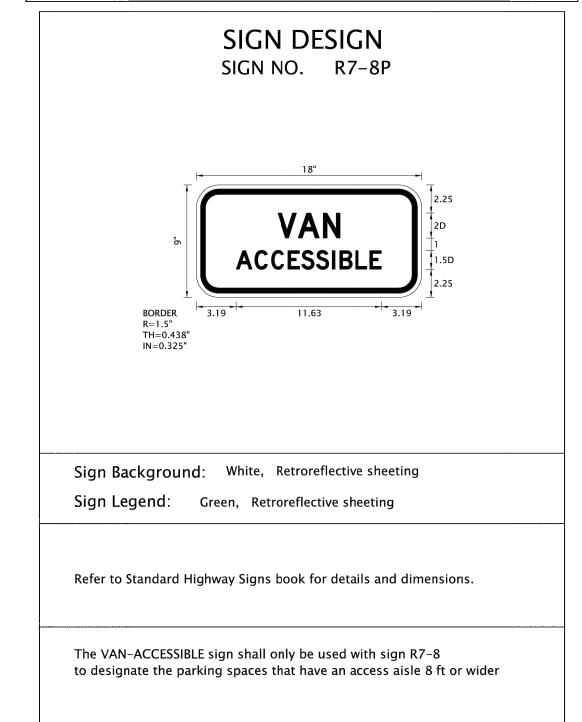


Figure 9

Pavement Marking Background: Optional: Blue, Retroreflective Pavement Marking Stencil: White, Retroreflective Pavement Marking Stencil: White, Retroreflective

LEGEND DIMENSIONS (INCHES)

MINIMUM 28 24 3

STANDARD 41 36 4

The pavement marking stencil shall be used to designate an accessible parking area reserved for vehicles with DMV permits.

OREGON TRANSPORTATION COMMISSION Standards for Accessible Parking Places August 2018

Figure 6

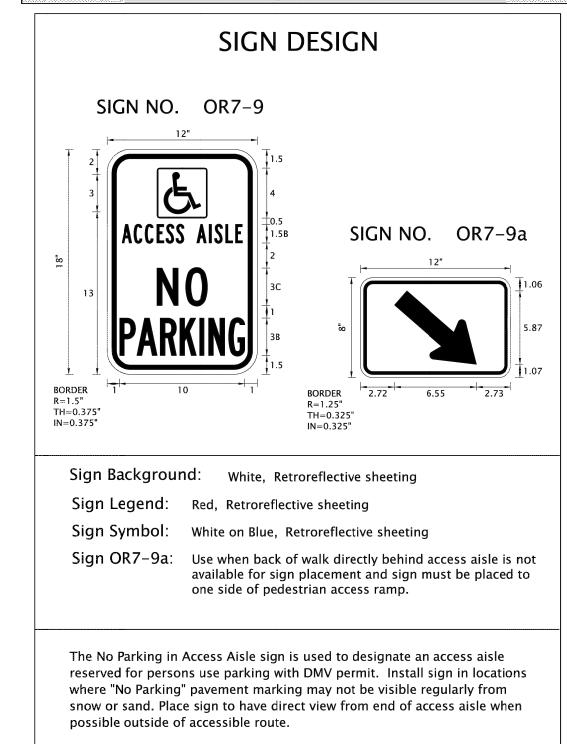


Figure 11

PARKING

PAR

The "No Parking" pavement marking is used to designate an access aisle reserved for persons use parking with a DMV permit. This marking shall be required for all access aisles next to accessible parking spaces. Engineering judgement should be used for placement location to give best visual location to prevent illegal use of access aisle. Yellow may be used instead of white to increase contrast between access aisle white lines and the "No Parking" legend.

Figure 7

OREGON TRANSPORTATION COMMISSION
Standards for Accessible Parking Places
August 2018

SIGN DESIGN
SIGN NO. R7-8



Sign Background: White, Retroreflective sheeting

Sign Legend: Green, Retroreflective sheeting
Sign Symbol: White on Blue, Retroreflective sheeting

Refer to Standard Highway Signs book for details.

The Disabled Person parking sign is used to designate a parking area reserved for vehicles with DMV permit as stated.

Figure 8

EXPIRES: 06/30/25
SIGNATURE DATE:

© AXIS DESIGN GROUP
THESE DRAWINGS ARE THE PROPERTY OF
AXIS DESIGN GROUP AND ARE NOT TO BE
REPRODUCED IN ANY MANNER EXCEPT WITH
THE PRIOR WRITTEN APPROVAL OF AXIS
DESIGN GROUP.

DESIGNGROUP
ARCHITECTURE & ENGINEERING, INC.

67149PE

OREGON

FIRWOOD
DESIGN GROUP
Reliable Engineering Solutions
359 E. HISTORIC COLUMBIA RIVER HWY
TROUTDALE, OREGON 97060
(503) 668-3737

11104 S.E. STARK STREET PORTLAND, OR 97216

T: 503.284.0988 | F:

503.546.9276

HERZOG MEIER OLKSWAGEN-VOLVO :W SERVICE BUILDING

REVISIONS

No. Description Date

1
2
3
4
5
6

DRAWN BY: BB

CHECKED BY: KG

JOB NO: E20-030

DATE: 7/26/2024

SHEET NO.

SHEET TITLE

C313

ISSUED FOR: LAND USE REVIEW

ADA PARKING DETAILS

SEDIMENT FENCE

RAWING NO. 875

6' MAXIMUM SPACING

FRONT VIEW

REVISED 10-31-19

FOR FURTHER INFORMATION

ON DESIGN CRITERIA SEE CHAPTER 4 OF CLEAN WATER SERVICES EROSION PREVENTION

AND SEDIMENT CONTROL PLANNING AND DESIGN MANUAL.

^N Services

CleanWater V


1" REBAR FOR BAG REMOVAL-


EXPANSION RESTRAINT


CATCH BASIN GRATE


CATCH BASIN-

STORM PIPE-

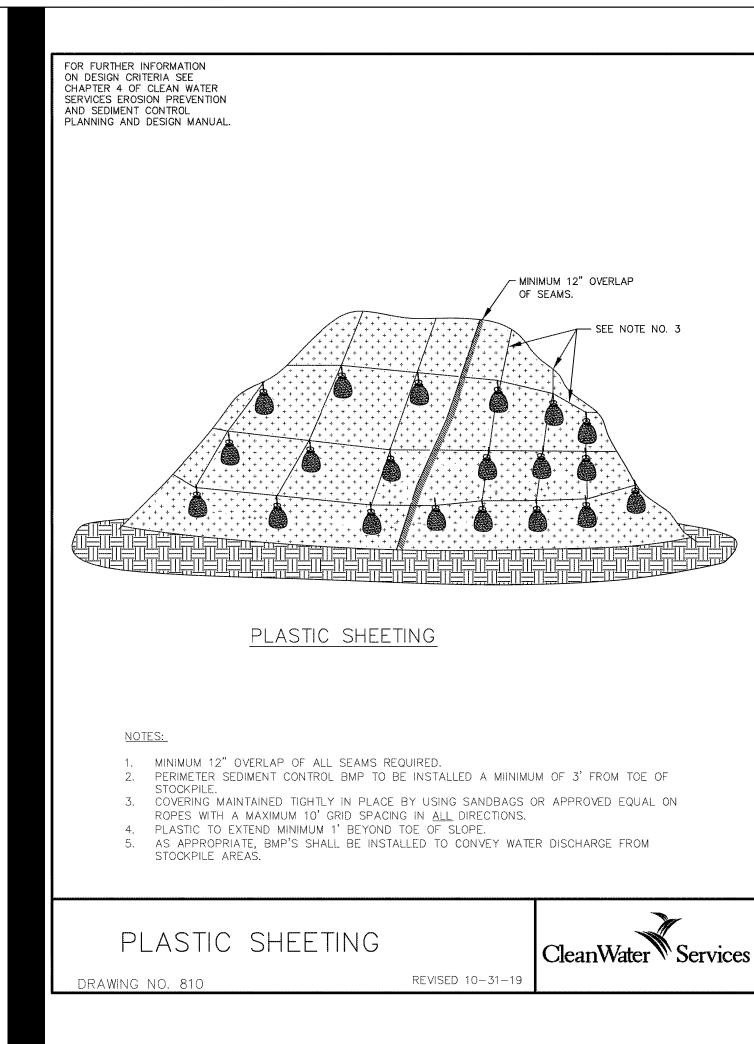

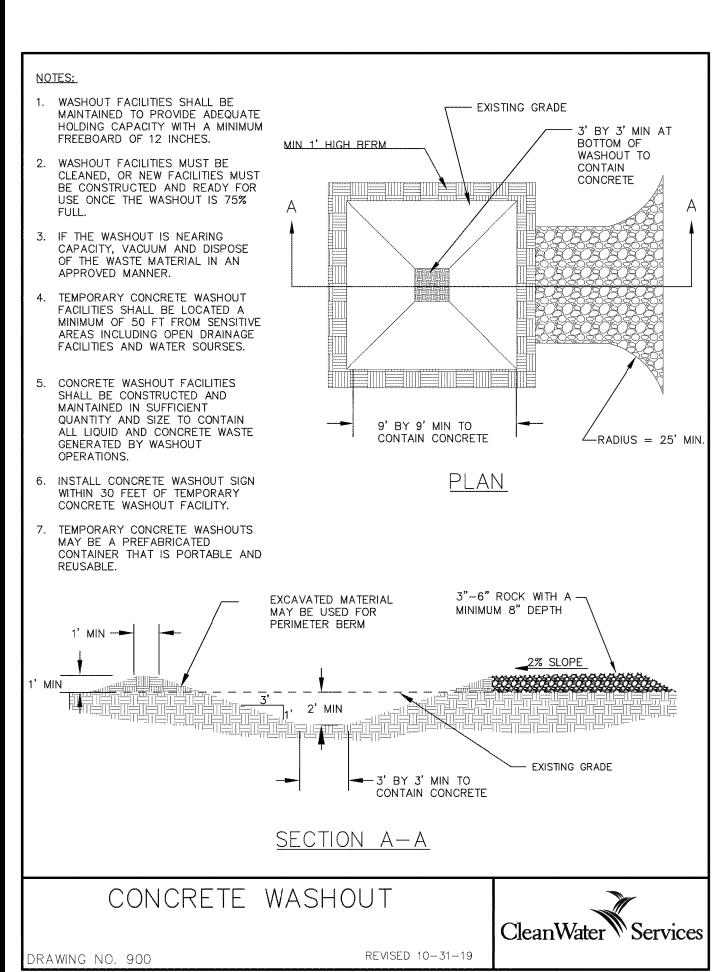

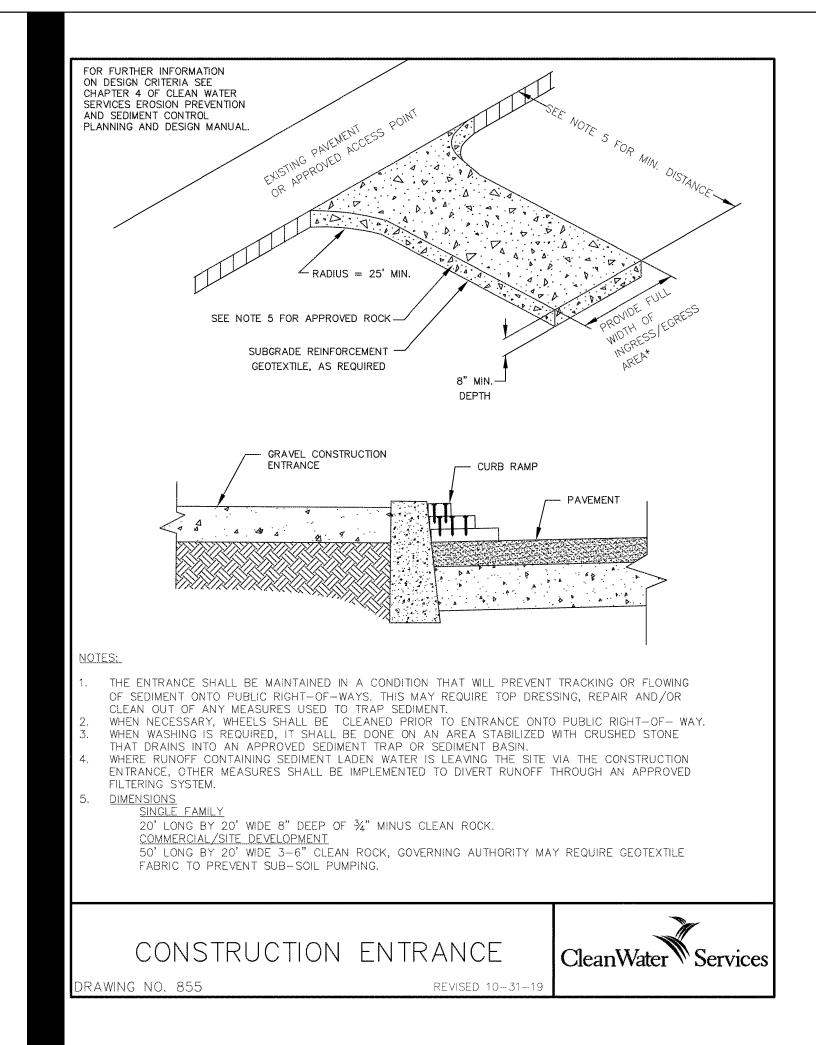

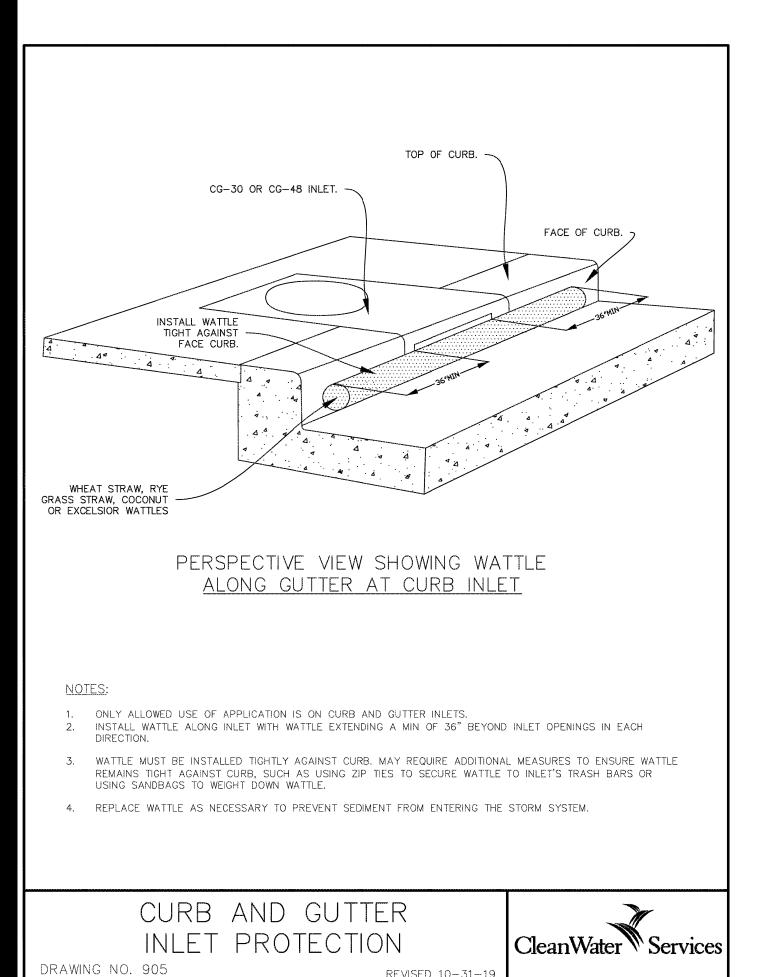

REVISED 10-31-19



EXPIRES: 06/30/25 SIGNATURE DATE: ____ © AXIS DESIGN GROUP THESE DRAWINGS ARE THE PROPERTY OF AXIS DESIGN GROUP AND ARE NOT TO BE



REPRODUCED IN ANY MANNER EXCEPT WITH

THE PRIOR WRITTEN APPROVAL OF AXIS

DESIGNGROUP 11104 S.E. STARK STREET PORTLAND, OR 97216 T: 503.284.0988 | F: 503.546.9276

FIRWOOD Reliable Engineering Solutions 359 E. HISTORIC COLUMBIA RIVER HWY TROUTDALE, OREGON 97060 (503) 668-3737

> MEIER SEN-VOLVO SE BUILDING HERZ LKSW, V SERN BEAVER VOL

No. Desc	cription	D
1	•	
2		
3		
4		
5		_
6		-
		\vdash
DRAWN BY:	ВВ	
CHECKED BY:	KG	
JOB NO: E20)-030	

SHEET NO.

SHEET TITLE

C314

ESC DETAILS